

DANIEL FIELD AIRPORT (DNL)

AUGUSTA, GA

AIRFIELD ELECTRICAL SYSTEM UPGRADE

GDOT PROJECT NO APXXX-XXXX-XX(XXX) RICHMOND


GMC PROJECT NO TAUG220004

JANUARY 2023

INDEX


SHEET NO.	DESCRIPTION
Sheet 1	TITLE SHEET
Sheet C2	PROJECT LAYOUT AND CONSTRUCTION SAFETY PHASING PLAN (OVERALL)
Sheets C3 - C9	PROJECT LAYOUT AND CONSTRUCTION SAFETY PHASING PLANS
Sheets GE0 - GE1	ELECTRICAL LEGENDS & NOTES
Sheet E0	OVERALL ELECTRICAL REFERENCE PLAN
Sheets ED1 - ED12	DEMOLITION PLANS
Sheets E1 - E8	5/23 LIGHTING & WIRING PLANS
Sheets E9 - E10	5/23 SIGN CHART AND LAYOUT PLANS
Sheets E11 - E12	ELECTRICAL VAULT PLANS
Sheets E13 - E21	ELECTRICAL DETAILS
Sheets E22 - E26	11/29 LIGHTING & WIRING PLANS
Sheets E27 - E28	11/29 SIGN CHART AND LAYOUT PLANS

DANIEL FIELD AIRPORT

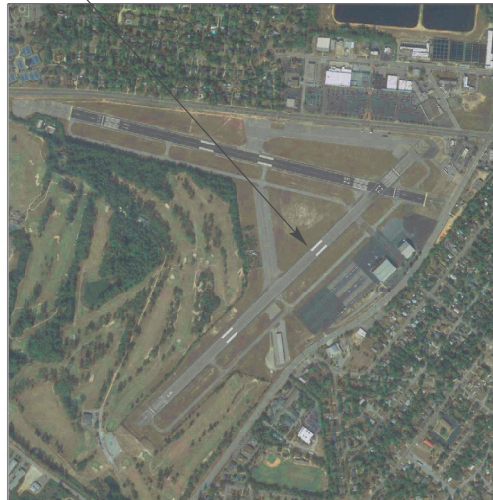


VICINITY MAP
N.T.S.

DANIEL FIELD AIRPORT

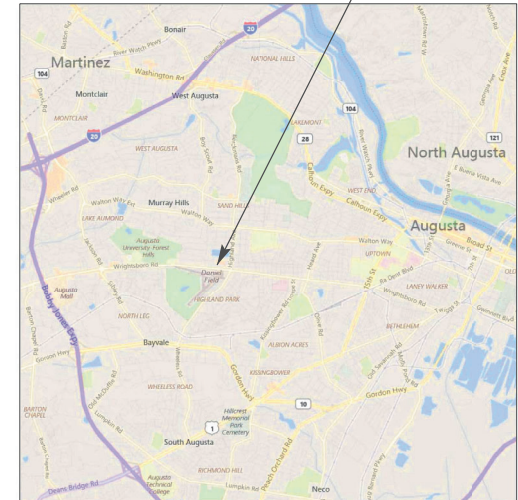

LOCATION MAP
N.T.S.

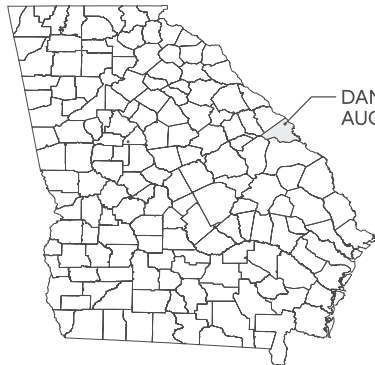

DANIEL FIELD AIRPORT
AUGUSTA, GA

STATE MAP
N.T.S.



PLANS PREPARED BY:



DATE: 01/20/2023



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REGISTERED ENGINEER
STATE OF GEORGIA

JOHN AVERRETT
LICENSE NO. 32362

BID	PHASE	WORK AREA	DURATION	DESCRIPTION
BASE BID	I	1	45	<ul style="list-style-type: none"> THIS PHASE SHALL CONSIST OF REMOVAL OF EXISTING LIGHTS, SIGNS AND ELECTRICAL CIRCUITS AND THE INSTALLATION OF NEW LIGHTS, SIGNS, NAVAIDS AND ELECTRICAL CIRCUITS. RUNWAY 5/23 CLOSED FOR DURATION OF WORK UTILIZE STAGING AREA 1
	II	2	28	<ul style="list-style-type: none"> THIS PHASE SHALL CONSIST OF REMOVAL OF EXISTING LIGHTS, SIGNS AND ELECTRICAL CIRCUITS AND THE INSTALLATION OF NEW LIGHTS, SIGNS, NAVAIDS AND ELECTRICAL CIRCUITS. RUNWAY 5/23 CLOSED FOR DURATION OF WORK UTILIZE STAGING AREA 2
	III	3	2	<ul style="list-style-type: none"> THIS PHASE SHALL CONSIST OF REMOVAL OF EXISTING LIGHTS, SIGNS AND ELECTRICAL CIRCUITS AND THE INSTALLATION OF NEW LIGHTS, SIGNS, NAVAIDS AND ELECTRICAL CIRCUITS. RUNWAY 5/23 AND 11/29 CLOSED FOR DURATION OF WORK UTILIZE STAGING AREA 1 AND 2 NIGHT WORK ONLY
ADD ALT #1	IV	4	25	<ul style="list-style-type: none"> THIS PHASE SHALL CONSIST OF REMOVAL OF EXISTING LIGHTS, SIGNS AND ELECTRICAL CIRCUITS AND THE INSTALLATION OF NEW LIGHTS, SIGNS, NAVAIDS AND ELECTRICAL CIRCUITS. RUNWAY 11/29 CLOSED FOR DURATION OF WORK UTILIZE STAGING AREA 2
	V	3	2	<ul style="list-style-type: none"> THIS PHASE SHALL CONSIST OF REMOVAL OF EXISTING LIGHTS, SIGNS AND ELECTRICAL CIRCUITS AND THE INSTALLATION OF NEW LIGHTS, SIGNS, NAVAIDS AND ELECTRICAL CIRCUITS. RUNWAY 5/23 AND 11/29 CLOSED FOR DURATION OF WORK UTILIZE STAGING AREA 1 AND 2 NIGHT WORK ONLY
	IV	5	18	<ul style="list-style-type: none"> THIS PHASE SHALL CONSIST OF REMOVAL OF EXISTING LIGHTS, SIGNS AND ELECTRICAL CIRCUITS AND THE INSTALLATION OF NEW LIGHTS, SIGNS, NAVAIDS AND ELECTRICAL CIRCUITS. RUNWAY 11/29 CLOSED FOR DURATION OF WORK UTILIZE STAGING AREA 1

LEGEND


- RSA— RUNWAY SAFETY AREA
- OFA— OBJECT FREE AREA
- RPZ— RUNWAY PROTECTION ZONE
- WORK AREA

STAGING AREA 1

#	LAT	LONG
①	33°27'48,77" N	82°02'18,51" W
②	33°27'49,46" N	82°02'17,67" W
③	33°27'48,07" N	82°02'17,69" W
④	33°27'48,76" N	82°02'16,84" W

STAGING AREA 2

#	LAT	LONG
①	33°28'10,34" N	82°02'21,94" W
②	33°28'10,25" N	82°02'20,76" W
③	33°28'09,36" N	82°02'22,05" W
④	33°28'09,27" N	82°02'20,87" W

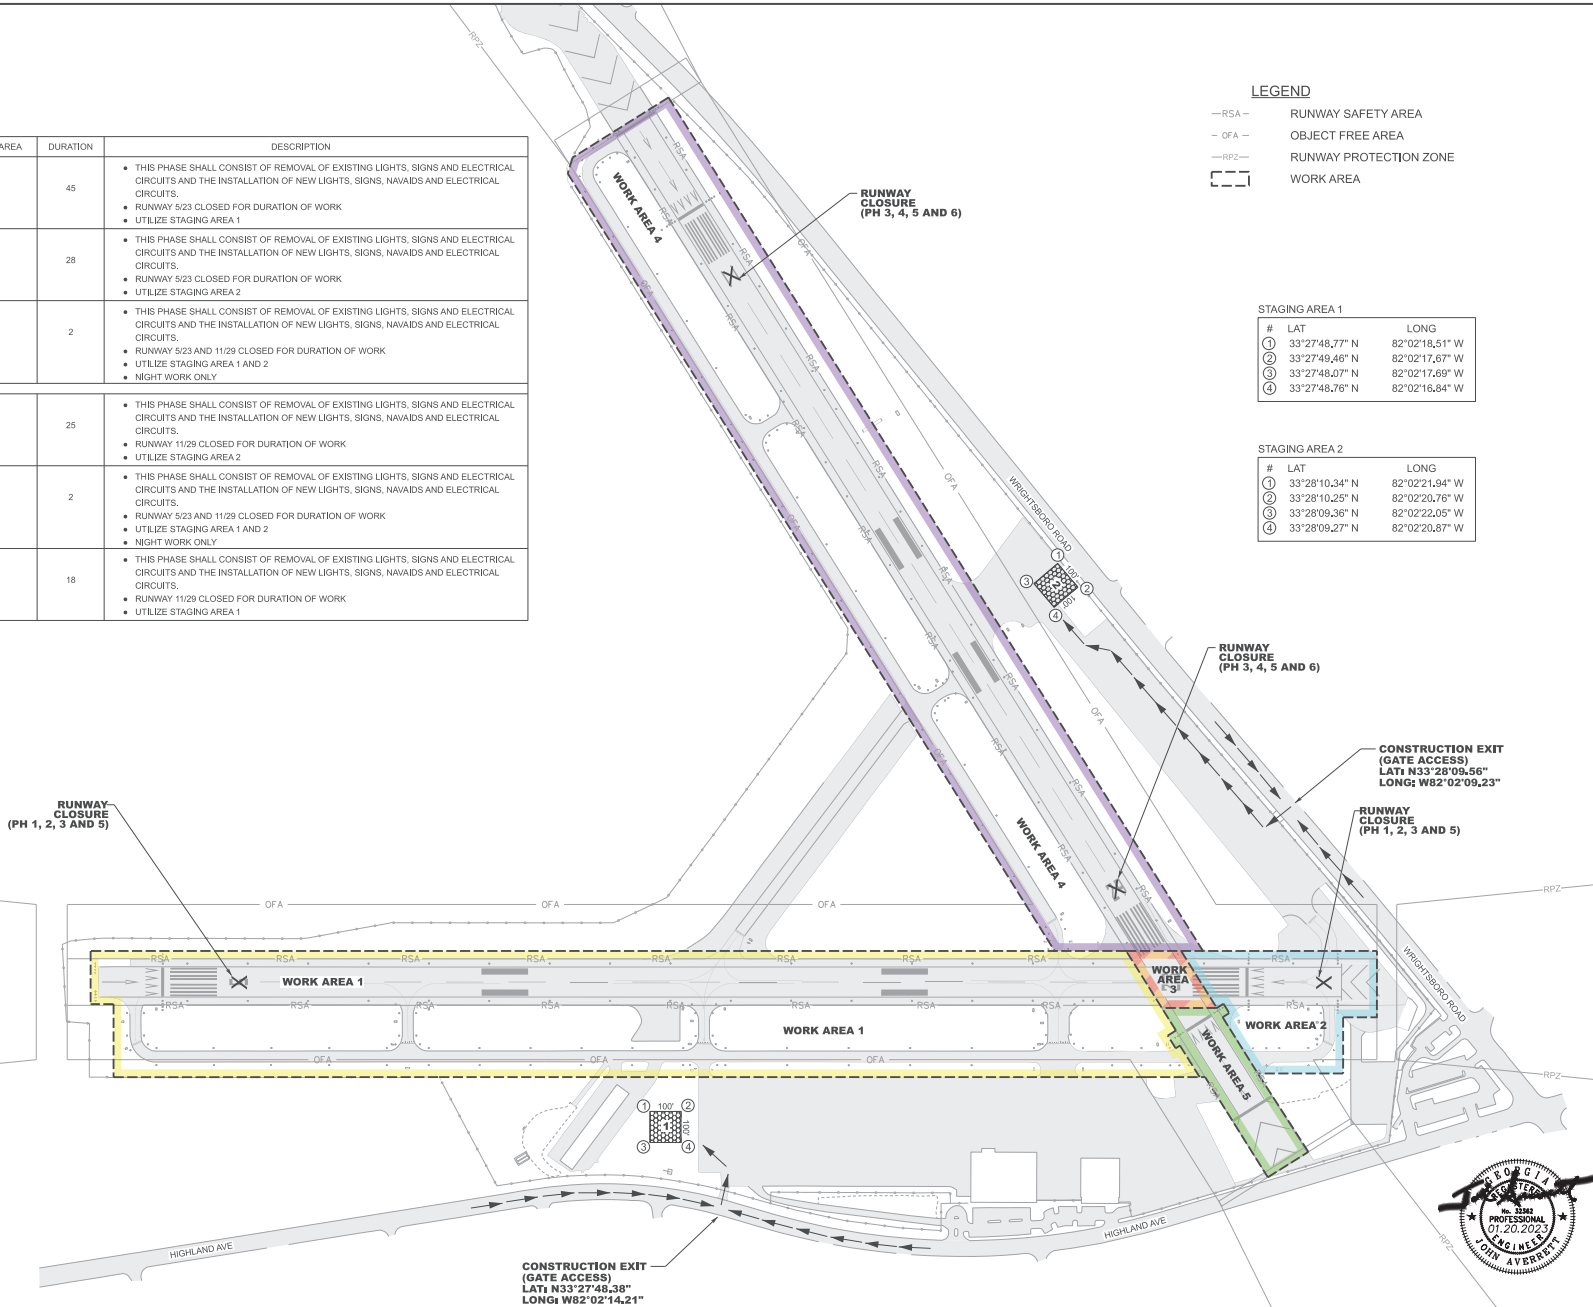

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drawn by:	CAM
checked by:	JEA


PROJECT LAYOUT AND AIRFIELD ELECTRICAL SYSTEM UPGRADE
DANIEL FIELD AIRPORT (DNL)
 AUGUSTA, GEORGIA
 AP019-XXXX-XX(245)
 TAUG220004
 SCALE: 1" = 200'



BID	PHASE	WORK AREA	DURATION	DESCRIPTION
BASE BID	1	1	45	<ul style="list-style-type: none"> THIS PHASE SHALL CONSIST OF REMOVAL OF EXISTING LIGHTS, SIGNS AND ELECTRICAL CIRCUITS AND THE INSTALLATION OF NEW LIGHTS, SIGNS, NAVAIDS AND ELECTRICAL CIRCUITS. RUNWAY 523 CLOSED FOR DURATION OF WORK UTILIZE STAGING AREA 1

LEGEND

—RSA—	RUNWAY SAFETY AREA
—OFA—	OBJECT FREE AREA
—RPZ—	RUNWAY PROTECTION ZONE
⌈⌋	WORK AREA

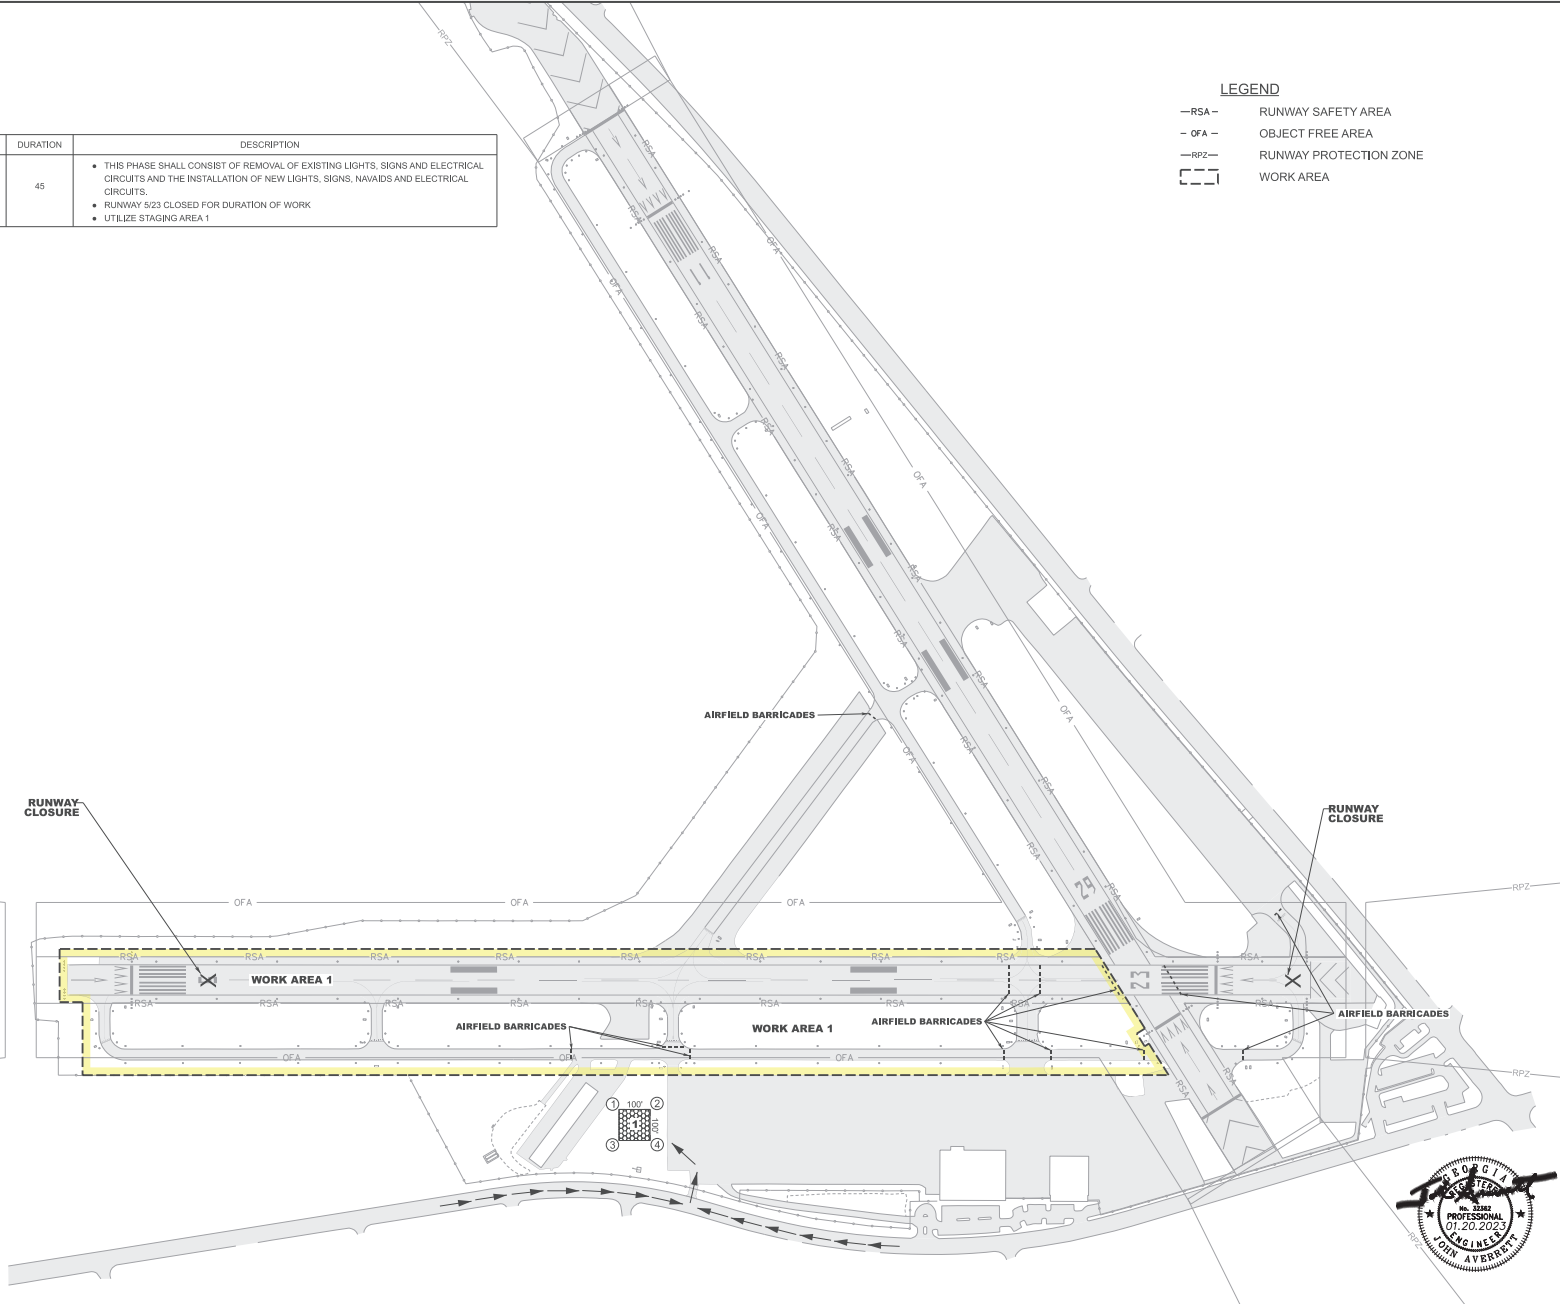

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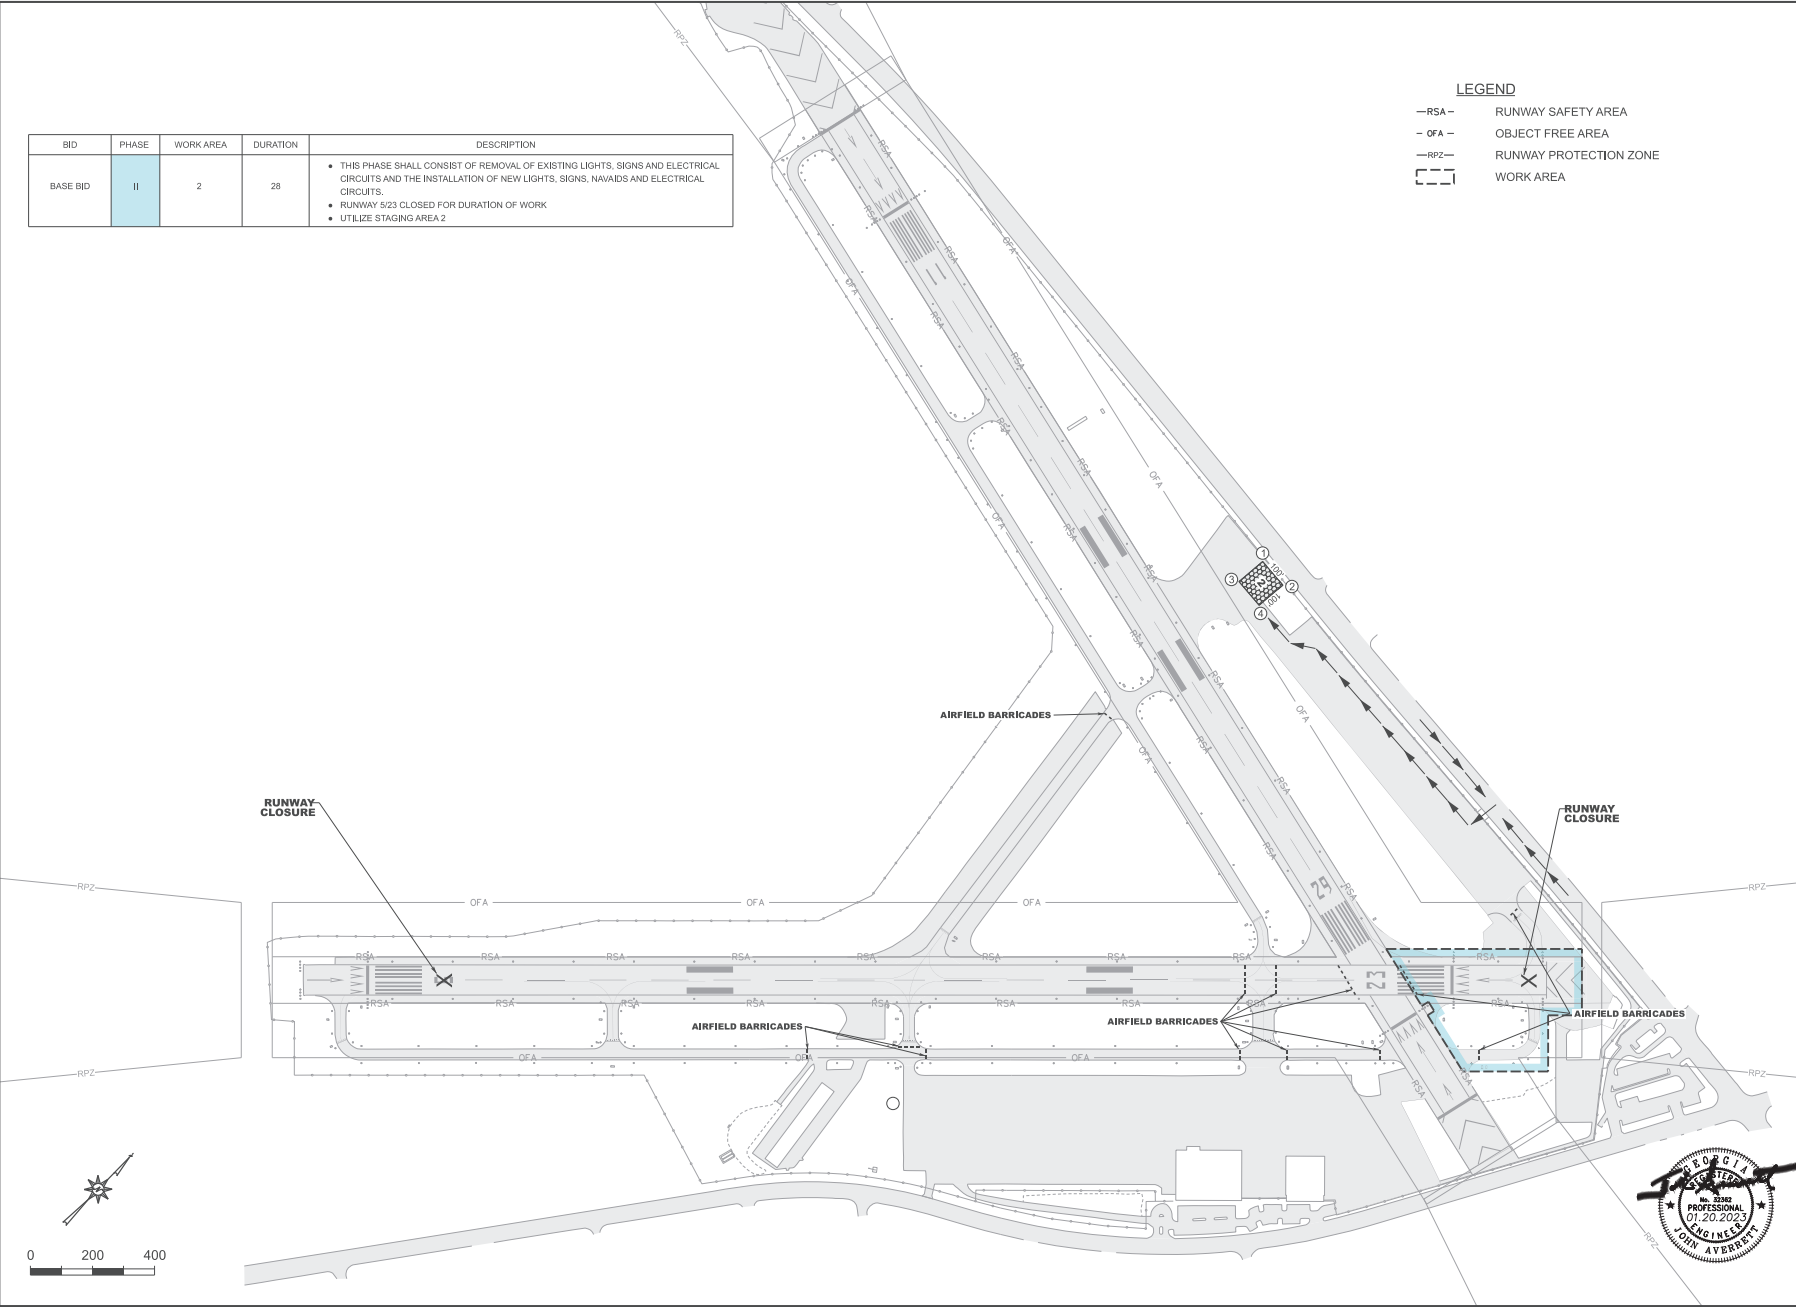
PROJECT LAYOUT AND CONSTRUCTION SAFETY PHASING PLAN (PHASE I)
AIRFIELD ELECTRICAL SYSTEM UPGRADE
DANIEL FIELD AIRPORT (DNL)
 AUGUSTA, GEORGIA
 AP019-XXXX-XX(245)
 TAUG220004
 SCALE: 1" = 200'

C3
Sheet 3 of 52

REGISTERED PROFESSIONAL ENGINEER
No. 22482
01-20-2023
JOHN AVERRETT

BID	PHASE	WORK AREA	DURATION	DESCRIPTION
BASE BID	II	2	28	<ul style="list-style-type: none"> THIS PHASE SHALL CONSIST OF REMOVAL OF EXISTING LIGHTS, SIGNS AND ELECTRICAL CIRCUITS AND THE INSTALLATION OF NEW LIGHTS, SIGNS, NAVAIDS AND ELECTRICAL CIRCUITS. RUNWAY 23 CLOSED FOR DURATION OF WORK UTILIZE STAGING AREA 2

- LEGEND**
- RSA— RUNWAY SAFETY AREA
 - OFA— OBJECT FREE AREA
 - RPZ— RUNWAY PROTECTION ZONE
 - [---] WORK AREA



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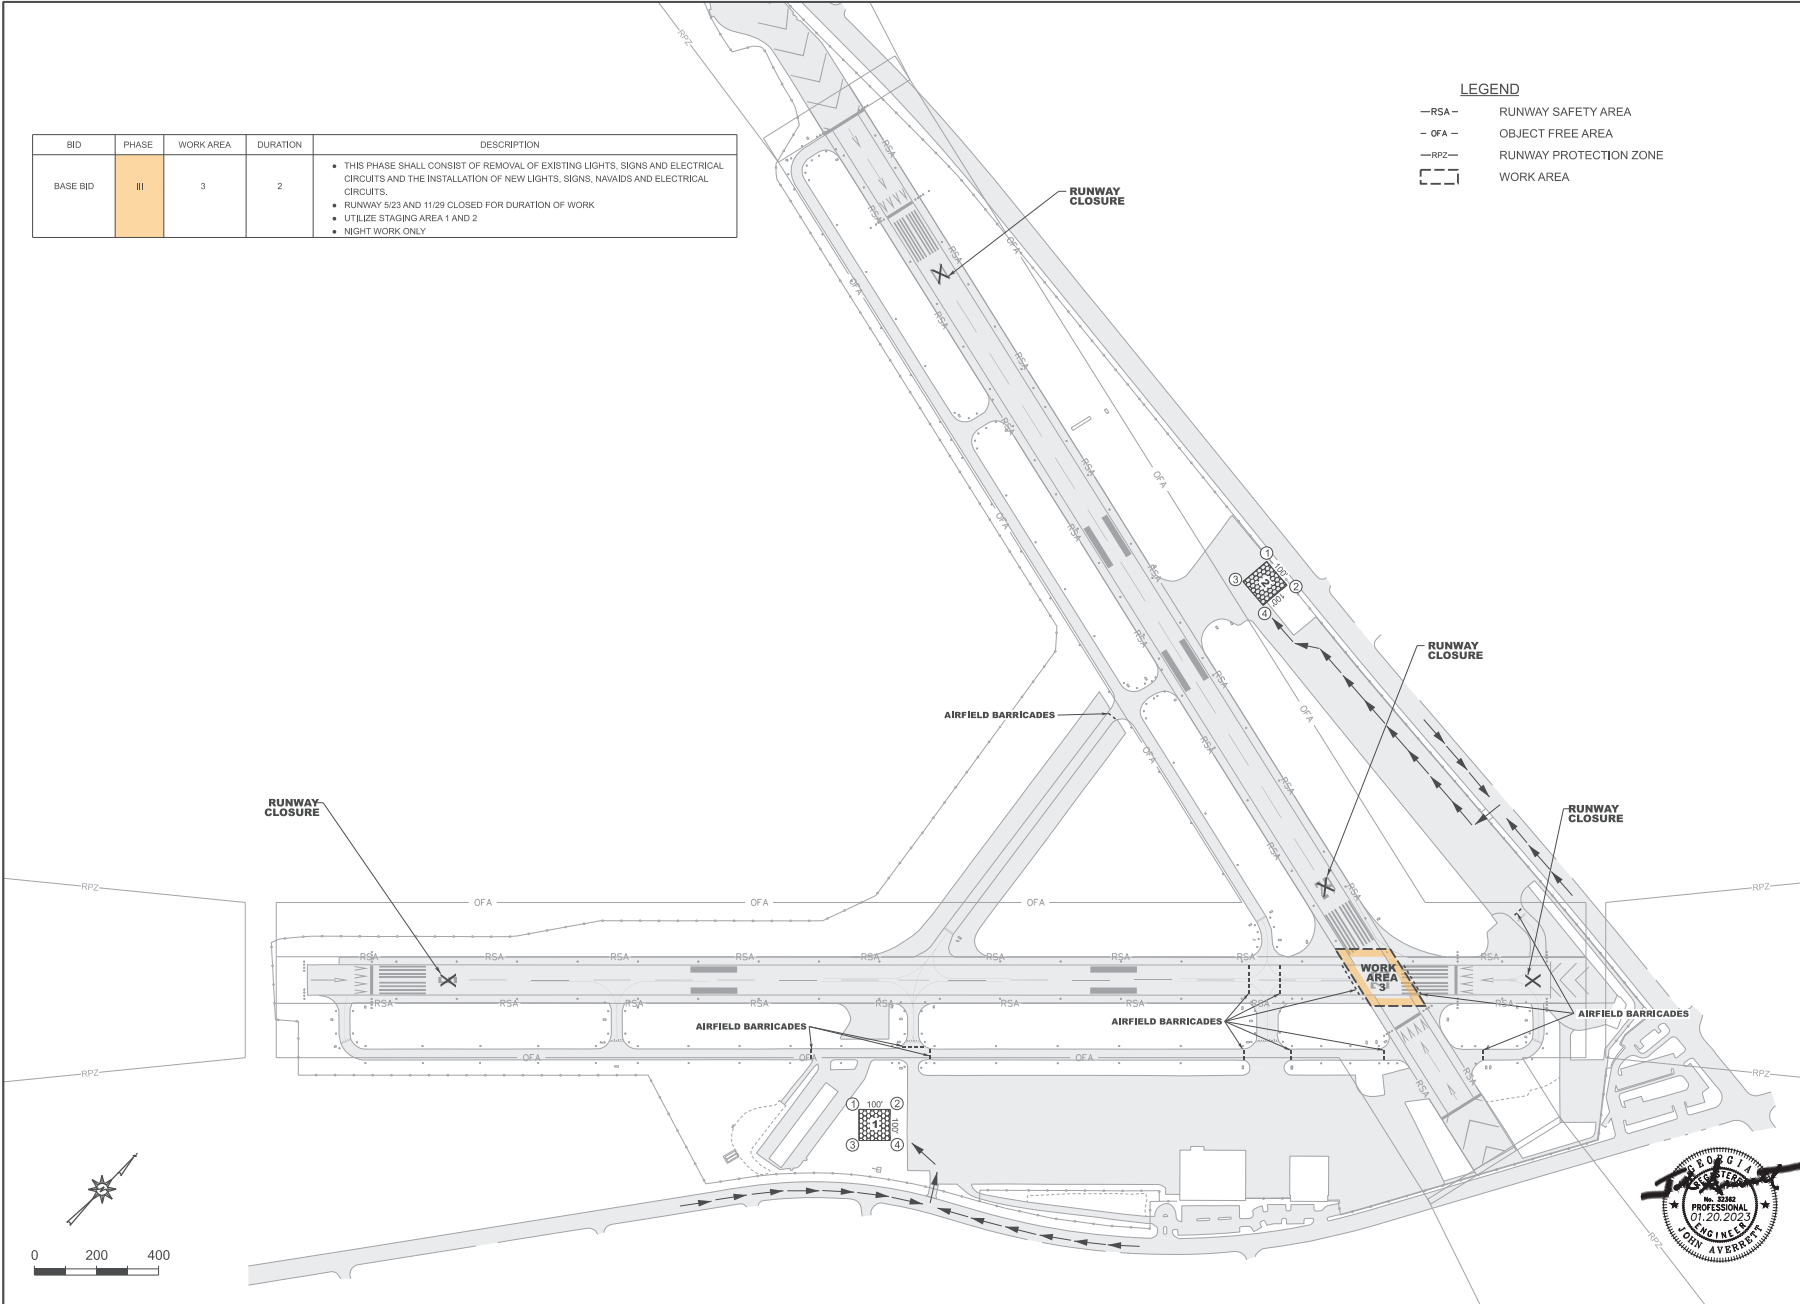
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AIRFIELD ELECTRICAL SYSTEM UPGRADE
DANIEL FIELD AIRPORT (DNL)
 AUGUSTA, GEORGIA
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PROJECT LAYOUT AND CONSTRUCTION SAFETY PHASING PLAN (PHASE II)

BID	PHASE	WORK AREA	DURATION	DESCRIPTION
BASE BID	III	3	2	<ul style="list-style-type: none"> THIS PHASE SHALL CONSIST OF REMOVAL OF EXISTING LIGHTS, SIGNS AND ELECTRICAL CIRCUITS AND THE INSTALLATION OF NEW LIGHTS, SIGNS, NAVAIDS AND ELECTRICAL CIRCUITS. RUNWAY 823 AND 1129 CLOSED FOR DURATION OF WORK UTILIZE STAGING AREA 1 AND 2 NIGHT WORK ONLY

- LEGEND**
- RSA- RUNWAY SAFETY AREA
 - OFA- OBJECT FREE AREA
 - RPZ- RUNWAY PROTECTION ZONE
 - [Dashed Box] WORK AREA



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PROJECT LAYOUT AND CONSTRUCTION SAFETY PHASING PLAN (PHASE II)

AIRFIELD ELECTRICAL SYSTEM UPGRADE DANIEL FIELD AIRPORT (DNL)

AUGUSTA, GEORGIA

AP019-XXXX-XX(245)

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SCALE: 1" = 200'


C5

Sheet 5 of 52

BID	PHASE	WORK AREA	DURATION	DESCRIPTION
ADD ALT #1	IV	4	25	<ul style="list-style-type: none"> THIS PHASE SHALL CONSIST OF REMOVAL OF EXISTING LIGHTS, SIGNS AND ELECTRICAL CIRCUITS AND THE INSTALLATION OF NEW LIGHTS, SIGNS, NAVAIDS AND ELECTRICAL CIRCUITS. RUNWAY 11/29 CLOSED FOR DURATION OF WORK UTILIZE STAGING AREA 2

LEGEND

—RSA—	RUNWAY SAFETY AREA
-OFA-	OBJECT FREE AREA
-RPZ-	RUNWAY PROTECTION ZONE
[---]	WORK AREA

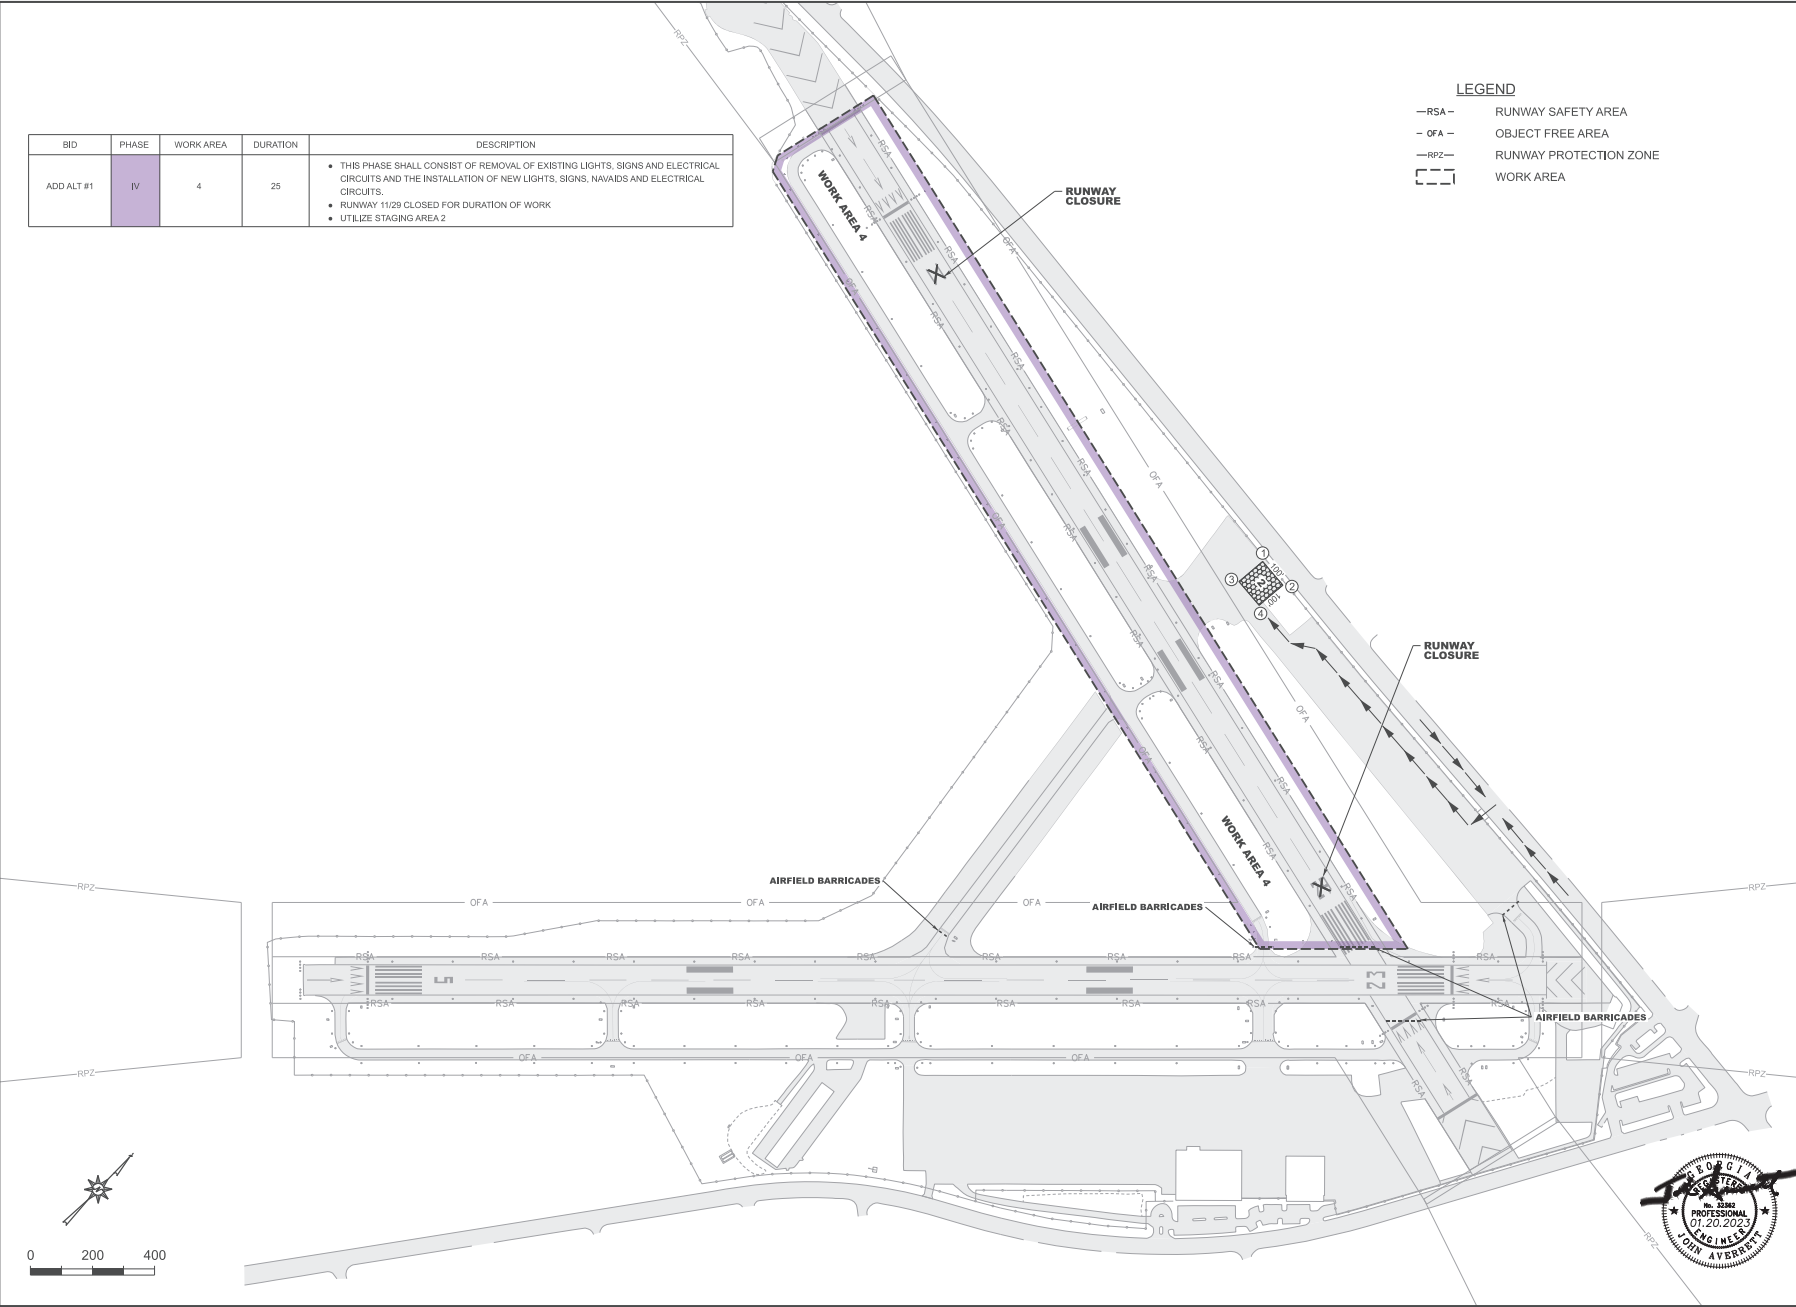

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AIRFIELD ELECTRICAL SYSTEM UPGRADE
DANIEL FIELD AIRPORT (DNL)
 AUGUSTA, GEORGIA
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PROJECT LAYOUT AND CONSTRUCTION SAFETY PHASING PLAN (PHASE II)




C6
 sheet 6 of 52

BID	PHASE	WORK AREA	DURATION	DESCRIPTION
ADD ALT #1	V	3	2	<ul style="list-style-type: none"> THIS PHASE SHALL CONSIST OF REMOVAL OF EXISTING LIGHTS, SIGNS AND ELECTRICAL CIRCUITS AND THE INSTALLATION OF NEW LIGHTS, SIGNS, NAVAIDS AND ELECTRICAL CIRCUITS. RUNWAY 5/23 AND 11/29 CLOSED FOR DURATION OF WORK UTILIZE STAGING AREA 1 AND 2 NIGHT WORK ONLY

LEGEND

—RSA—	RUNWAY SAFETY AREA
—OFA—	OBJECT FREE AREA
—RPZ—	RUNWAY PROTECTION ZONE
[]	WORK AREA

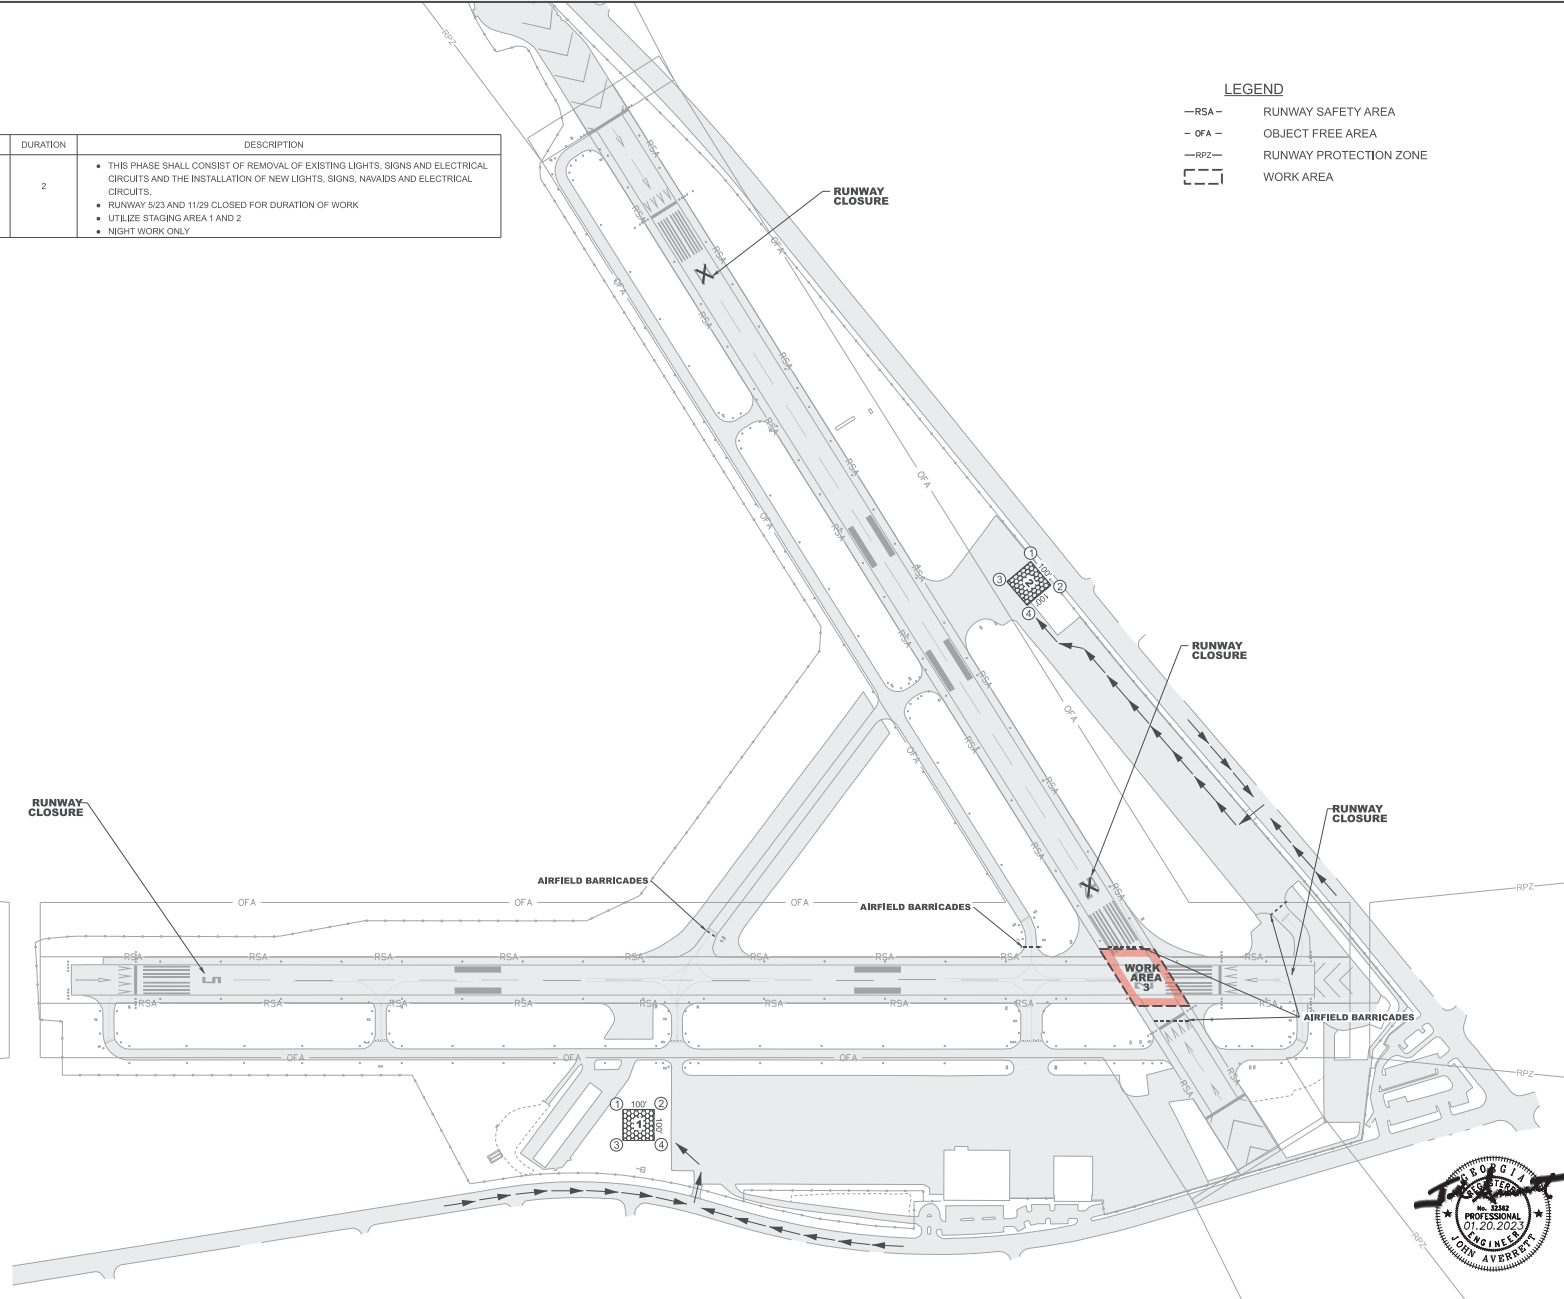

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PROJECT LAYOUT AND CONSTRUCTION SAFETY PHASING PLAN (PHASE V)
AIRFIELD ELECTRICAL SYSTEM UPGRADE
DANIEL FIELD AIRPORT (DNL)
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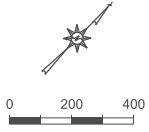
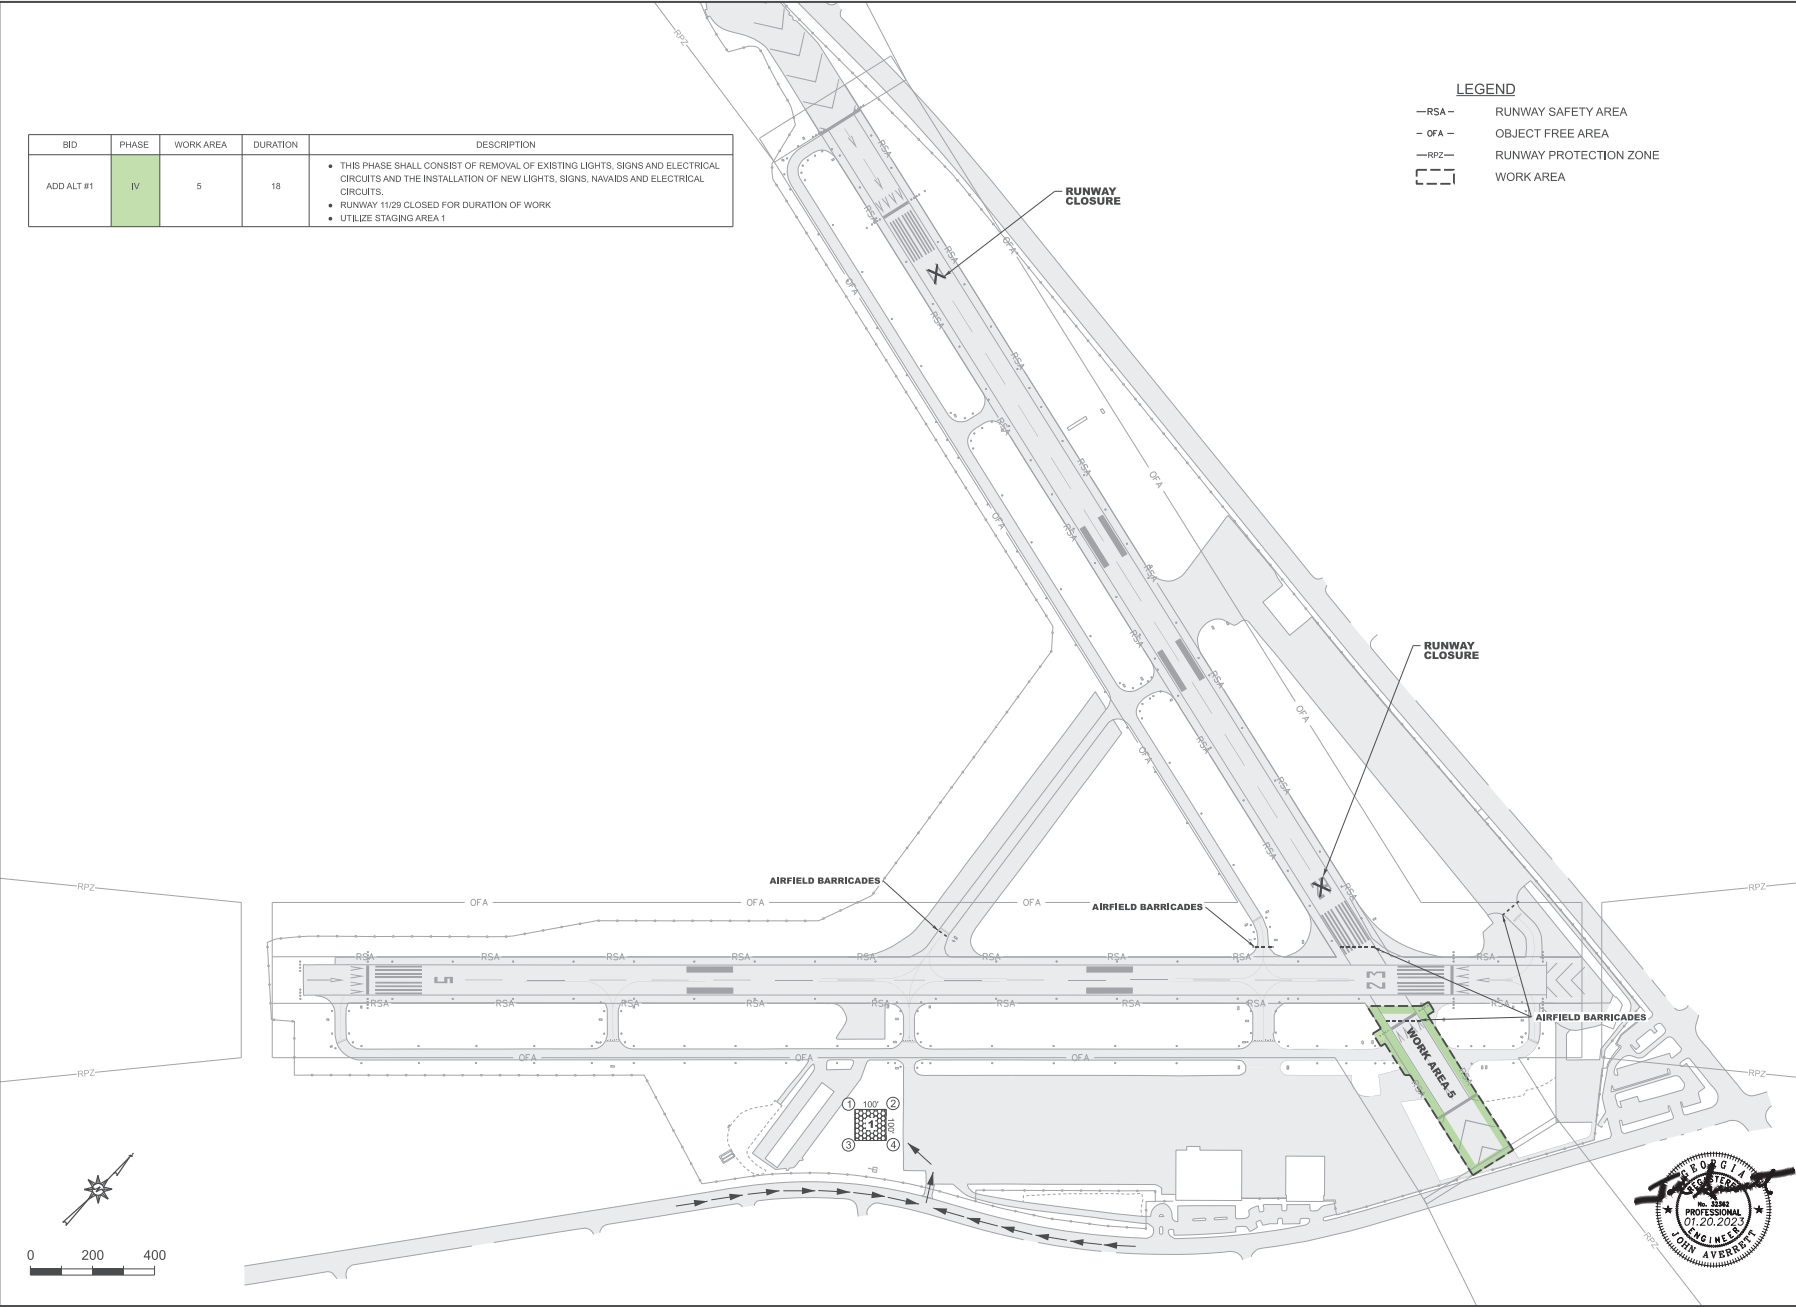


C7
 sheet 7 of 52

BID	PHASE	WORK AREA	DURATION	DESCRIPTION
ADD ALT #1	IV	5	18	<ul style="list-style-type: none"> THIS PHASE SHALL CONSIST OF REMOVAL OF EXISTING LIGHTS, SIGNS AND ELECTRICAL CIRCUITS AND THE INSTALLATION OF NEW LIGHTS, SIGNS, NAVAIDS AND ELECTRICAL CIRCUITS. RUNWAY 11/29 CLOSED FOR DURATION OF WORK UTILIZE STAGING AREA 1

LEGEND

—RSA—	RUNWAY SAFETY AREA
-OFA-	OBJECT FREE AREA
-RPZ-	RUNWAY PROTECTION ZONE
[]	WORK AREA



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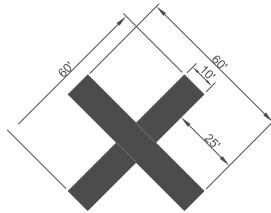
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PROJECT LAYOUT AND CONSTRUCTION SAFETY PHASING PLAN (PHASE VI)
AIRFIELD ELECTRICAL SYSTEM UPGRADE DANIEL FIELD AIRPORT (DNL)
 AUGUSTA, GEORGIA
 AP019-XXXX-XX(245)
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 SCALE: 1" = 200'

C8
 sheet 8 of 52

SAFETY NOTES


1. ALL CONSTRUCTION VEHICLES AND EQUIPMENT OPERATING ON THE AIRPORT PROPERTY SHALL BE MARKED WITH STANDARD FAA WARNING FLAGS OR BEACONS. VEHICLES AND EQUIPMENT OPERATING DURING HOURS OF DARKNESS OR REDUCED VISIBILITY SHALL BE LIGHTED WITH A FLASHING CIRCULAR AMBER EMERGENCY WARNING LIGHT, ACCORDING TO FAA ADVISORY CIRCULAR 150/5370-2F.
2. ALL FOREMAN'S AND SUPERINTENDENT'S VEHICLES SHALL CONTAIN RADIOS CAPABLE OF TRANSMITTING AND RECEIVING THE UNICOM FREQUENCY OF 123.05 MHZ. NORMAL RADIO COMMUNICATIONS BETWEEN CONTRACTOR PERSONNEL WILL NOT BE ALLOWED ON THE UNICOM CONTROL OR ANY OTHER FAA FREQUENCY.
3. CONTRACTOR SHALL USE EXTREME CAUTION WHILE WORKING NEAR FUEL FARM FACILITY. FLAMMABLE FUEL TANKS EXIST IN THE FUEL FARM.
4. ALL OPEN EXCAVATIONS SHALL BE ADEQUATELY MARKED AND SIGNED.
5. THE CONTRACTOR SHALL NOT AT ANY TIME BE ON THE RUNWAY UNLESS THE ENGINEER OR AIRPORT PERSONNEL GIVES PRIOR APPROVAL.
6. THE CONTRACTOR IS RESPONSIBLE FOR ALL CONSTRUCTION, MAINTENANCE, REMOVAL AND CLEANUP OF ALL HAUL ROUTES (ON AND OFF AIRPORT PROPERTY).
7. ALL ACTIVE AIRPORT OPERATIONAL AREAS ADJACENT TO WORK AREAS SHALL BE SEPARATED BY BARRICADES.
8. RUNWAY WILL BE CLOSED AS NECESSARY FOR WORK PERFORMED IN THE OFA.
9. RUNWAY CLOSURE X'S MUST BE SECURED BY DOUBLE-BAGGED YELLOW SANDBAGS PLACED AT EVERY CORNER AND APPROXIMATELY 10' SPACING BETWEEN EACH BAG. IF A BAG IS DAMAGED OR TARNISHED, CONTRACTOR IS REQUIRED TO CLEAN DEBRIS AND REPLACE APPROPRIATELY.



RUNWAY CLOSURE DETAIL
Not to scale


NOTE:
CONTRACTOR SHALL MAINTAIN ALL RUNWAY CLOSURES THROUGHOUT THE DURATION OF THE PROJECT.

PART 77 DETAIL
Not to scale

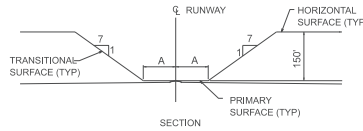

PAVEMENT	SAFETY AREA WIDTH
RUNWAY 5/23	150'
RUNWAY 11/29	150'


SAFETY AREA DIMENSIONS

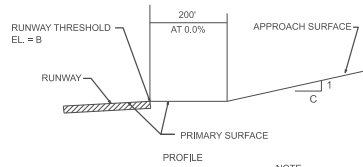

RUNWAY END	A	B	C
RUNWAY 5	250	373.9	20
RUNWAY 23	250	422.3	20
RUNWAY 11	250	421.4	34
RUNWAY 29	250	418.7	20

FAR PART 77 SURFACES

NOTE:
THE PART 77 SURFACE IS CENTERED ON THE RUNWAY AT THE CENTERLINE ELEVATION AND TO THE WIDTH INDICATED. THE PART 77 SURFACE IS LOCATED ON THE PROFILE OF THE EXTENDED RUNWAY CENTERLINE AT THE RUNWAY THRESHOLD ELEVATION TO A POINT 200' BEYOND EACH THRESHOLD. THE SECTION THEN RISES ALONG THE SLOPES INDICATED.

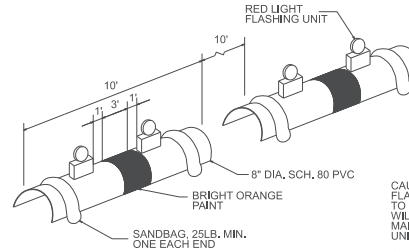

AIRFIELD BARRICADE DETAIL
Not to scale

CAUTION LIGHTS TO BE RED IN COLOR AND FLASHING DURING HOURS OF DARKNESS. UNITS TO BE PLACED ADJACENT TO EACH OTHER, THERE WILL BE NO DIRECT PAYMENT FOR FURNISHING, MAINTENANCE, OR REMOVAL OF THIS BARRIER. UNITS MUST BE SECURED TO PVC.

ALL BARRICADES SHALL DELINEATE THE AREA TO BE PROTECTED AND THE BARRICADE LINE SHALL EXTEND TO 10' OFF THE EDGE OF EITHER SIDE OF ANY PAVEMENT.



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CONSTRUCTION SAFETY NOTES AND DETAILS
AIRFIELD ELECTRICAL SYSTEM UPGRADE
DANIEL FIELD AIRPORT (DNL)
AUGUSTA, GEORGIA

AP019-XXXX-XX(245)
TAUG220004
SCALE: NOT TO SCALE

C9

Sheet 9 of 52

SWITCH LEGEND	
\$	WALL SWITCH SPST 42" AFF TO CENTER UNO 20A 120/277V.
\$M	MOTOR RATED TOGGLE SWITCH 30A 120/277V 2HP MAX 120/240V.

AIRFIELD LIGHTING LEGEND	
	MEDIUM INTENSITY TAXIWAY LIGHT (BLUE LENS), BASE MOUNTED.
	MEDIUM INTENSITY TAXIWAY LIGHT (BLUE LENS), STAKE MOUNTED.
	MEDIUM INTENSITY RUNWAY LIGHT (COLOR AS INDICATED, G=GREEN, R=RED, W=WHITE, Y=YELLOW, O=OBSCURE), BASE MOUNTED.
	MEDIUM INTENSITY RUNWAY LIGHT (COLOR AS INDICATED, G=GREEN, R=RED, W=WHITE, Y=YELLOW, O=OBSCURE), STAKE MOUNTED.
	GUIDANCE SIGN. SEE SIGN LAYOUT SHEETS E9, E10, E27, & E28.
	PAPI LIGHT UNIT. "EX" INDICATES EXISTING TO REMAIN.
	PAPI CONTROL UNIT.
	UNIDIRECTIONAL REIL, HEAD AND POWER CONTROL UNIT.
	OMNI DIRECTIONAL REIL, HEAD AND POWER CONTROL UNIT.
	FIELD LIGHTNING ARRESTOR.

AIRFIELD LIGHTING DEMOLITION LEGEND	
	EXISTING AIRFIELD MEDIUM INTENSITY LIGHT TO BE REMOVED UNO.
	EXISTING RUNWAY 5KV CIRCUIT/WIRING TO BE REMOVED.
	EXISTING TAXIWAY 5KV CIRCUIT/WIRING TO BE REMOVED.
	EXISTING PAPI 5KV CIRCUIT/WIRING TO BE REMOVED.
	EXISTING DUCT BANK TO REMAIN.
	EXISTING JUNCTION CAN / BOX TO REMAIN.
	EXISTING REIL LIGHT UNIT AND ALL ASSOCIATED COMPONENTS TO BE REMOVED.
	EXISTING PAPI LIGHT UNIT AND ALL ASSOCIATED COMPONENTS TO BE REMOVED UNO.

POWER LEGEND	
	PANELBOARD 208/120V, SURFACE MOUNTED.
	PANELBOARD, 480/277V, SURFACE MOUNTED.
	DISCONNECT SWITCH, NEMA 1, NON-FUSED, SUBSCRIPT INDICATES DISCONNECT SWITCH AMP RATING - SEE DISCONNECT SWITCH SCHEDULE.
	DISCONNECT SWITCH, NEMA 1, FUSED, SUBSCRIPT INDICATES DISCONNECT SWITCH AMP RATING - SEE DISCONNECT SWITCH SCHEDULE.
	DISCONNECT SWITCH, NEMA 3R, FUSED, SUBSCRIPT INDICATES DISCONNECT SWITCH AMP RATING - SEE DISCONNECT SWITCH SCHEDULE.
	COMBINATION MOTOR STARTER DISCONNECT SWITCH.
	PHOTOELECTRIC CELL AS SPECIFIED ON PLANS. MOUNT IN INCONSPICUOUS LOCATION ABOVE ROOF FACING NORTH.
	NEW TRANSFORMER.
	EXHAUST FAN.
	DAMPNER MOTOR.
	EXISTING PANELBOARD, SURFACE MOUNTED.
	JUNCTION BOX WALL MOUNTED AT HEIGHT REQUIRED WITH FLEXIBLE CONNECTION TO EQUIPMENT.
	JUNCTION BOX CEILING/WALL MOUNTED. REFER TO SPECIFICATIONS FOR COLOR REQUIREMENTS FOR COVER.
	SURGE PROTECTION DEVICE
	METER BASE
	GROUND BUS BAR
	PAPI CONSTANT CURRENT REGULATOR, "X" INDICATES PAPI NAME.
	RUNWAY CONSTANT CURRENT REGULATOR, "X" INDICATES RUNWAY NAME.
	TAXIWAY CONSTANT CURRENT REGULATOR, "X" INDICATES TAXIWAY NAME.
	DUPLEX RECEPTACLE WALL MOUNTED 18" A.F.F. TO CENTER UNO.
	SIMPLEX RECEPTACLE WALL MOUNTED 18" A.F.F. TO CENTER UNO.
	DUPLEX GROUND FAULT CIRCUIT INTERRUPTER (5mA) RECEPTACLE WALL MOUNTED 18" A.F.F. TO CENTER UNO. "WP" INDICATES WEATHERPROOF "IN-USE" HEAVY DUTY METAL COVER.
	THERMOSTAT.
	TIME CLOCK.
	RADIO CONTROLLER.

CONDUIT & WIRING LEGEND	
	ELECTRICAL HANDHOLE PULL OR JUNCTION BOX AS NOTED
	CONDUIT OR RACEWAY EXPOSED TO VIEW. RUN PARALLEL OR PERPENDICULAR TO STRUCTURE CONCEAL FROM VIEW AS MUCH AS POSSIBLE.
	CONDUIT OR RACEWAY CONCEALED IN CEILING CAVITY OR WALL.
	CONDUIT OR RACEWAY UNDERGROUND OR CONCEALED IN FLOOR SLAB.
	OVERHEAD ELECTRICAL CABLE.
	UNDERGROUND PRIMARY.
	UNDERGROUND SECONDARY.
	GROUNDING CONDUCTOR. SEE PLANS & DETAILS FOR MORE INFORMATION.
	EXISTING ELECTRICAL LINE TO BE REMOVED.
	CONDUIT STUB UP.
	CONDUIT STUB DOWN.
	CONDUIT STUB IN.
	PHASE CONDUCTOR, NEUTRAL CONDUCTOR AND ISOLATED GROUND CONDUCTOR.
	HOMERUN. TICKS INDICATES NUMBER OF CONDUCTORS. NO TICKS INDICATES 1 PHASE, 1 NEUTRAL, 1 GROUND CONDUCTOR.
	UNDERGROUND HOMERUN. ARROW INDICATES NUMBER OF CIRCUITS. TICKS INDICATES NUMBER OF CONDUCTORS. NO TICKS INDICATES 1 PHASE, 1 NEUTRAL, 1 GROUND CONDUCTOR.
	EXPOSED TO VIEW HOMERUN. ARROW INDICATES NUMBER OF CIRCUITS. TICKS INDICATES NUMBER OF CONDUCTORS. NO TICKS INDICATES 1 PHASE, 1 NEUTRAL, 1 GROUND CONDUCTOR.
	GROUND ROD AS SPECIFIED, 3/4"x10'. SEE DETAIL 7/E20.
	ELECTRICAL MANHOLE. SEE DETAIL 485/E20.
	CONDUIT MARKER IN-GRADE. SEE DETAIL 4/E14.
	DUCT MARKER IN-GRADE. SEE DETAIL 4/E14.
	PROPOSED RUNWAY 5-23 (R1) 5KV CIRCUIT (BASE BID) (DASHES/TICKS INDICATES NUMBER OF CABLES).
	PROPOSED TAXIWAY 'D' (T1) 5KV CIRCUIT, TAXIWAY 'A/D' (T2) 5KV CIRCUIT (BASE BID) AND TAXIWAY 'A' (T3) 5KV CIRCUIT (ALTERNATE) (DASHES/TICKS INDICATES NUMBER OF CABLES).
	PROPOSED PAPI 5-23 5KV CIRCUIT (BASE BID) (DASHES/TICKS INDICATES NUMBER OF CABLES).
	PROPOSED RUNWAY 11-29 (R2) 5KV CIRCUIT (ALTERNATE) (DASHES/TICKS INDICATES NUMBER OF CABLES).
	PROPOSED 120V WINDCONE CIRCUIT (BASE BID).

LIGHTING LEGEND	
	1' x 4' SURFACE TROFFER, WRAPAROUND OR ENCLOSED STRIP FIXTURE - SURFACE MOUNTED OR CHAINING. LETTER "X" INDICATES FIXTURE TYPE. SEE LUMINAIRE SCHEDULE. THE LETTER "E" INDICATES THAT THE FIXTURE IS EQUIPPED WITH EMERGENCY BATTERY.
	WALL MOUNTED LIGHT FIXTURE. LETTER "X" INDICATES FIXTURE TYPE. SEE LUMINAIRE SCHEDULE. THE LETTER "E" INDICATES THAT THE FIXTURE IS EQUIPPED WITH EMERGENCY BATTERY.
	EMERGENCY LIGHT WITH BATTERY POWER, CONNECTED TO UNSWITCHED HOTLEG. LETTER "X" INDICATES FIXTURE TYPE. SEE LUMINAIRE SCHEDULE.



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DRAWN BY:	J.R.A., J.D.Z.
CHECKED BY:	J.E.A.

**AIRFIELD ELECTRICAL UPGRADE
DANIEL FIELD AIRPORT (DNL)**

AUGUSTA, GEORGIA
AP-019-XXX-XX(245)
GMC NUMBER : TAUG220004
SCALE: NOT TO SCALE



**ELECTRICAL LEGENDS
& NOTES**

GEO
Sheet 10 of 52

VAUG220003

GENERAL ELECTRICAL NOTES

1. THE CONTRACTOR IS RESPONSIBLE TO FURNISH ALL LABOR, EQUIPMENT, MATERIALS, AND SUPPLIES AS NECESSARY FOR A NEAT, COMPLETE, AND SATISFACTORY OPERATING ELECTRICAL SYSTEMS WHICH CONFORMS TO ALL LOCAL CODES, PLANS, AND SPECIFICATIONS.
2. ELECTRICAL CONTRACTOR SHALL REVIEW ENTIRE SET OF CONTRACT DOCUMENTS INCLUDING BUT NOT NECESSARILY LIMITED TO ALL CIVIL, ELECTRICAL AND ENTIRE PROJECT MANUAL. ELECTRICAL CONTRACTOR SHALL ACKNOWLEDGE AND INCLUDE IN THE SCOPE OF WORK (CONTRACT) ALL CONDITIONS PERTINENT TO THE COMPLETION OF THE ELECTRICAL WORK. ELECTRICAL CONTRACTOR SHALL FULLY COORDINATE ELECTRICAL WORK WITH THE INSTALLATION OF WORK BY ALL OTHER TRADES AND MAKE NECESSARY FIELD ADJUSTMENTS AS REQUIRED TO ACCOMMODATE THE INSTALLATION. ALL OF THE ABOVE SHALL BE INCLUDED IN THE SCOPE OF WORK AT NO ADDITIONAL COST TO THE OWNER.
3. ELECTRICAL DRAWINGS ARE DIAGRAMMATIC IN NATURE, IT SHALL NOT BE THE INTENT OF ISSUED PLANS AND/OR SPECIFICATIONS TO SHOW EVERY MINOR DETAIL OF CONSTRUCTION. THE ELECTRICAL CONTRACTOR IS EXPECTED TO FURNISH AND INSTALL ALL NECESSARY ITEMS FOR A COMPLETE AND OPERATING SYSTEM.
4. ALL INSTALLATIONS SHALL CONFORM TO THE LATEST EDITION OF ALL ENFORCED INTERNATIONAL BUILDING CODE AND ALL FAA CIRCULAR ADVISORIES AT THE TIME OF PERMIT.
5. EACH BIDDER SHALL VISIT THE JOB SITE PRIOR TO BIDDING TO FAMILIARIZE THEMSELVES WITH EXISTING CONDITIONS AND TO ASCERTAIN THE EXTENT OF WORK REQUIRED. FAILURE TO VISIT SITE SHALL NOT EXCUSE CONTRACTOR FROM PERFORMING REQUIRED WORK NOR SHALL IT BE AN ACCEPTABLE REASON FOR REQUESTING ADDITIONS TO THE CONTRACT.
6. ALL MATERIALS AND EQUIPMENT SHALL BE NEW AND SHALL BE LISTED BY AN AGENCY SUCH AS UNDERWRITER'S LABORATORIES (UL), ELECTRICAL TESTING LABORATORY (ETL), ETC AND ACCEPTED BY THE LOCAL AUTHORITY HAVING JURISDICTION. FOR THE USE INTENDED WHERE A STANDARD FOR SUCH MATERIALS AND USE EXISTS. ALL ITEMS OF THE SAME TYPE AND RATING SHALL BE IDENTICAL AND OF THE SAME MANUFACTURER.
7. THE WORD "PROVIDE" MEANS THAT THIS CONTRACTOR SHALL FURNISH, FABRICATE, ERECT, CONNECT, AND COMPLETELY INSTALL SYSTEMS IN PROPER OPERATING CONDITION. ALL LABOR, PRODUCT OPTIONS, ACCESSORIES AND INCIDENTAL MATERIALS REQUIRED SHALL BE INCLUDED AS PART OF THIS WORK TO COMPLETE THE INSTALLATION.
8. ALL ELECTRICAL CONNECTIONS WILL BE CODE COMPLIANT WITH N.E.C.
9. WIRING SYSTEMS SHALL CONSIST OF COPPER WIRING INSTALLED IN CONDUIT, MINIMUM WIRE SIZE SHALL BE #12AWG, MINIMUM CONDUIT SIZE SHALL BE 3/4".
10. CONDUCTORS SHALL BE 99% COPPER (NO ALUMINUM CONDUCTORS WILL BE ACCEPTED), MINIMUM SIZE #12 AWG-3/4" C.
11. SUBSURFACE CONDUIT SHALL BE SCHEDULE 40 PVC UNO. FOR RUNS GREATER THAN 50 FEET IN LENGTH, VERTICAL TURN UPS SHALL BE GRS SWEEP 90S WITH A BITUMASTIC COATING UNO.
12. CONTRACTOR SHALL REPAIR ANY DISTURBED AREA TO SAME COMPACTION, GRADE, SLOPE, ETC. AS ORIGINAL AREA INCLUDING REPLACEMENT OF SOD, GRASS, ROCK, GRAVEL, RIP-RAP, ETC. TO THE SATISFACTION OF THE OWNER AND ENGINEER.
13. ANY AREA OF CONSTRUCTION DAMAGED DURING THIS CONTRACT SHALL BE REPAIRED TO MATCH ADJACENT SURFACES.
14. WITHIN ALL AREAS OF WORK, ALL UNUSED OR ABANDONED ELECTRICAL CONDUIT, CONDUCTORS, FITTINGS AND SUPPORTS SHALL BE REMOVED.
15. CLEAN UP ALL DEBRIS AROUND CONSTRUCTION SITE DAILY.
16. PROVIDE COMPLETE AIRFIELD LIGHTING SYSTEMS AS INDICATED ON THE CONTRACT DRAWINGS AND SPECIFIED, INCLUDING BUT NOT LIMITED TO, RUNWAY AND TAXIWAY LIGHTS, THRESHOLD LIGHTS, SIGNS, PAPI'S, REIL'S, LIGHTING CONTROL PANEL, RADIO CONTROLLER, TRANSFORMERS, CCRs, BASE-CANS, GROUNDING, AND ASSOCIATED WIRING AND CONCRETE PADS AS INDICATED.
17. PROVIDE ELECTRICAL SERVICE AND POWER DISTRIBUTION AS INDICATED ON THE CONTRACT DRAWINGS AND SPECIFIED, INCLUDING BUT NOT LIMITED TO, VAULT BUILDING PANELBOARDS, TRANSFER SWITCH, GROUNDING, AND ASSOCIATED WIRING.
18. MAINTAIN A MINIMUM 4" CLEARANCE BETWEEN 5KV AND 600 VOLT NONMETALLIC CONDUITS AS INDICATED IN THE CABLE TRENCH DETAIL, INCLUDING WITHIN EQUIPMENT ENCLOSURES, SUCH AS WITHIN CCR'S. MAINTAIN A MINIMUM 6" CLEARANCE BETWEEN CONTROL CABLES AND ALL POWER CABLES AS INDICATED IN THE CABLE TRENCH DETAIL, INCLUDING WITHIN EQUIPMENT ENCLOSURES.
19. DO NOT INSTALL 5KV CABLES IN SAME RACEWAY WITH 600 VOLT CABLES.
20. TERMINATION OF PHASE, NEUTRAL AND GROUNDING CONDUCTORS SHALL BE MADE TO INDIVIDUAL TERMINALS / LUGS AT PANELS, DISCONNECTS, DEVICES, ETC.
21. PROVIDE WARNING TAPE FOR UNDERGROUND CONDUITS AS SPECIFIED IN SPECIFICATION L-110 AND AS INDICATED ON DETAILS. INSTALL WARNING TAPE ABOVE THE FULL LENGTH OF THE CONDUIT RUNS AND AT A MAXIMUM OF 4" BELOW GRADE.
22. WHERE STEEL CONDUIT OR COPPER CONDUCTORS EMERGE FROM CONCRETE INTO SOIL, APPLY DIRECT BURIAL TAPE WRAP THE THE CONDUIT OR CONDUCTORS TO PREVENT CORROSION AS SPECIFIED IN SPECIFICATION SECTION L-109. TAPE WRAP SHALL BE EQUAL TO 3M TEMFLEX 1700 VINYL ELECTRICAL TAPE. INSTALL PER THE MANUFACTURER'S INSTRUCTIONS.
23. ALL WORK OF THIS CONTRACT REQUIRING POWER INTERRUPTIONS TO EQUIPMENT SHALL BE COORDINATED WITH THE OWNER. THE OWNER WILL NEED AT LEAST A 48 HOUR NOTIFICATION. WORK REQUIRING INTERRUPTIONS SHALL BE CONDUCTED DURING THE TIMES AND DAYS STIPULATED BY THE OWNER.
24. CONSTANT CURRENT REGULATORS SHALL BE CALIBRATED AND TESTED IN ACCORDANCE WITH SPECIFICATION L-109.
25. AT SUBMITTAL COMPLETION, REMOVE STANDING WATER AND DEBRIS FROM ALL BASE-CANS.

ELECTRICAL DEMOLITION NOTES

1. PARTIAL AND TOTAL DEMOLITION OF PORTIONS SHALL BE PERFORMED ALONGS WITH ALL NECESSARY MODIFICATIONS TO THAT PORTION OF THE EXISTING BUILDING WHICH SHALL REMAIN SO THAT IT CONTINUES TO FUNCTION UNAFFECTED BY THE DEMOLITION AND ASSOCIATED NEW CONSTRUCTION.
2. WHERE INCLUDED AS PART OF THE CONTRACT DOCUMENTS, THE DRAWINGS INDICATE THE GENERAL AREAS OF WORK INVOLVED. HOWEVER, THE ELECTRICAL CONTRACTOR SHALL PERFORM WORK OUTSIDE THOSE AREAS SHOWN AS IS NECESSARY TO COMPLY WITH THE INTENT OF THIS SECTION.
3. THE ELECTRICAL CONTRACTOR SHALL FAMILIARIZE THEMSELVES WITH THE EXISTING SITE WITH THE WORK OF ALL OTHER TRADES AND INCLUDE ALL WORK NECESSARY TO COMPLY WITH THE INTENT OF THE DEMOLITION.
4. IT SHALL BE UNDERSTOOD THAT FIELD CONDITIONS MAY BE ENCOUNTERED DURING THE EXECUTION OF THIS CONTRACT WHICH WILL REQUIRE EXTENSION OR RELOCATION OF EXISTING SYSTEMS OR EQUIPMENT WHICH ARE NOT SPECIFICALLY SHOWN ON THE DRAWINGS, BUT WHICH ARE REQUIRED TO MEET THE STATED INTENT THAT THE BUILDING CONTINUE TO FUNCTION UNAFFECTED BY THE DEMOLITION AND ASSOCIATED NEW CONSTRUCTION. THE ELECTRICAL CONTRACTOR SHALL INCLUDE SUCH WORK AS WOULD NORMALLY BE EXPECTED IN AN EXISTING ELECTRICAL SYSTEM TYPE.
5. THE ELECTRICAL CONTRACTOR SHALL PROVIDE ALL TOOLS, EQUIPMENT, LABOR, ETC. IN ORDER TO ACCOMPLISH THE DEMOLITION PORTION OF THE PROJECT.
6. THE ELECTRICAL CONTRACTOR SHALL INCLUDE COORDINATION WITH THE GENERAL CONTRACTOR AND SUCH DEMOLITION OF THE EXISTING ELECTRICAL SYSTEMS AS IS NECESSARY SO THAT THE DEMOLITION WORK OF THE GENERAL CONTRACTOR SHALL NOT DAMAGE THOSE PORTIONS OF THE ELECTRICAL SYSTEMS WHICH ARE TO REMAIN IN SERVICE, ARE TO BE REUSED, OR ARE TO BECOME THE PROPERTY OF THE OWNER.
7. TURN OVER ALL SALVAGEABLE MATERIALS AS NOTED, ITEMS SHOWN AS BEING REMOVED AND NOT REINSTALLED. ITEMS NOT DIRECTED OR REQUESTED TO BE TURNED OVER TO THE OWNER SHALL BE DISPOSED OF BY THE ELECTRICAL CONTRACTOR.
8. EQUIPMENT OR MATERIALS WHICH ARE TO BE REUSED OR TURNED OVER TO THE OWNER SHALL BE CAREFULLY REMOVED, CLEANED, AND STORED IN A CLEAN AND DRY AREA. SHOULD THE ELECTRICAL CONTRACTOR ENCOUNTER SUCH EQUIPMENT WHICH IS NOT IN SATISFACTORY CONDITION FOR REUSE AND NOT IN WORKING ORDER, THE ELECTRICAL CONTRACTOR SHALL NOTIFY THE ARCHITECT/ENGINEER IMMEDIATELY.
9. WHERE EXISTING BRANCH CIRCUITS AND SYSTEMS ARE INTERRUPTED BY NEW WORK OR SYSTEMS (ELECTRICAL, COMMUNICATIONS, ETC.), EXTEND AND RECONNECT THOSE CIRCUITS AND SYSTEMS. WHERE THOSE CIRCUITS OR SYSTEMS MUST REMAIN IN SERVICE DURING THE EXECUTION OF THIS CONTRACT, PROVIDE TEMPORARY CONNECTIONS UNTIL FINAL CONNECTIONS ARE COMPLETE.
10. THE INFORMATION CONTAINED IN THE DEMOLITION PLANS IS NOT CONSIDERED FULLY ACCURATE AS IT PERTAINS TO THE EXACT QUANTITY AND LOCATION IN THE FIELD. THE INFORMATION WAS OBTAINED FROM ASBUILTS AND LIMITED SITE VISITS. IT IS THE CONTRACTOR'S RESPONSIBILITY TO FIELD VERIFY THE LOCATIONS, SERVICE, AND QUANTITY OF ALL EXISTING ELECTRICAL COMPONENTS PRIOR TO BEGINNING DEMOLITION WORK. THE INFORMATION ON THE DEMOLITION PLANS IS TO BE USED AS A GUIDE TO THE CONTRACTOR TO COMPLETE THE DESIGN INTENT SHOWN. EXISTING ITEMS TO BE RE-USED CAN BE FOUND ON THE NEW WORK PLANS.
11. BEFORE COMMENCEMENT OF DEMOLITION WORK ALL CIRCUITS THAT ARE BEING WORKED ON AT THE TIME SHALL BE SHUT DOWN AND PROVIDE A LOCKOUT/TAGOUT PROCEDURE AT THE ELECTRICAL VAULT. THE ASSOCIATED CIRCUIT BEING WORKED ON AT THAT TIME SHALL HAVE ITS EXISTING SAFETY CUTOFF REMOVED. DO NOT WORK ON ANY LIVE CIRCUITS!

ELECTRICAL ABBREVIATIONS

A	AMP	AMPERE
ACSR	ALUMINUM CONDUCTOR STEEL-REINFORCED	
AF	AIRFIELD	
AFG	ABOVE FINISHED GRADE	
AFF	ABOVE FINISHED FLOOR	
AIC	AMPS INTERRUPTING CAPACITY (SYM RMS)	
ALT	ALTERNATE	
AWG	AMERICAN WIRE GAUGE	
BSDC	BARE SOFT DRAWN COPPER	
C	CONDUIT	
CCR	CONSTANT CURRENT REGULATOR	
CKT	CIRCUIT	
CU	COPPER	
DETD	DUAL ELEMENT TIME DELAY	
EC	EMPTY CONDUIT	
ELEC	ELECTRIC OR ELECTRICAL	
EPR	ETHYLENE-PROPYLENE RUBBER INSULATION	
EX	EXISTING TO REMAIN	
EXIST	EXISTING	
FAA	FEDERAL AVIATION ADMINISTRATION	
GFI	GROUND FAULT INTERRUPTER	
G	GROUND	
GRS	GALVANIZED RIGID STEEL	
IN-PL	IN PLACE	
KV	KILOVOLT	
KVA	KILOVOLT AMPERES	
KW	KILOWATT	
MIN	MINIMUM	
N12	NEMA 12 RATED FOR DUST ENCLOSURE	
N3R	NEMA 3R RATED FOR EXTERIOR USE	
NIC	NOT IN THIS CONTRACT	
NEC	NATIONAL ELECTRIC CODE	
PNL	PANEL	
P	POLE	
PH	PHASE	
PSI	POUNDS PER SQUARE INCH	
PVC	POLYVINYL CHLORIDE	
RE	REPLACE EXISTING	
RECP	RECEPTACLE	
REQD	REQUIRED	
RL	EXISTING ITEM TO BE RELOCATED	
RM	EXISTING ITEM TO BE REMOVED	
RU	RACK UNIT	
RW	RUNWAY	
SPD	SURGE PROTECTIVE DEVICE	
SPEC	SPECIFICATIONS	
SWBD	SWITCHBOARD	
TVSS	TRANSIENT VOLTAGE SURGE SUPPRESSION	
TW	TAXIWAY	
TYP	TYPICAL	
UG	UNDERGROUND	
UNO	UNLESS NOTED OTHERWISE	
V	VOLT	
VA	VOLT AMPERE	
W	WATT	
WP	WEATHERPROOF	
XFMR	TRANSFORMER	
#	NUMBER	



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ELECTRICAL LEGENDS & NOTES

**AIRFIELD ELECTRICAL UPGRADE
DANIEL FIELD AIRPORT (DNL)**

AUGUSTA, GEORGIA
AP019-XXX-XX(245)
GMC NUMBER : TAUG220004
SCALE: NOT TO SCALE



ISSUE DATE

TOOCS SUBMITTAL	1/20/2023
DESIGNED BY:	J.D.Z.
DRAWN BY:	J.R.A., J.D.Z.
CHECKED BY:	J.E.A.

GE1
Sheet 11 of 52

VAUG220003




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TOOK SUBMITTAL	1/20/2023
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**AIRFIELD ELECTRICAL UPGRADE
 DANIEL FIELD AIRPORT (DNL)**
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 AP019-XXX-XX(245)
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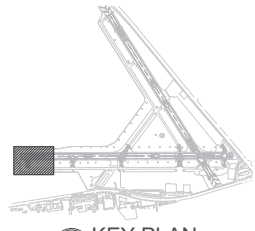
**AIRFIELD LIGHTING
 DEMOLITION PLAN
 RUNWAY 5/23 -
 PART 1**
ED1
 Sheet 13 of 52



GENERAL NOTES:
 1. REFER TO SHEET GE1 FOR GENERAL ELECTRICAL DEMOLITION NOTES.

- REMOVE ALL EXISTING RUNWAY LIGHTS, TAXIWAY LIGHTS, THRESHOLD LIGHTS, SIGNS, REILS, PAPI'S AND ASSOCIATED BASE CANS, TRANSFORMERS, AND CONCRETE PADS. RESTORE TURF AS REQUIRED. REMOVE ALL ASSOCIATED BURIED CABLES, COUNTER-POISES, CONDUCTORS, ANY CONDUITS THAT ARE ACCESSIBLE FOR REMOVAL, AND THOSE THAT ARE INACCESSIBLE SHALL BE ABANDONED IN-PLACE.
- ALL EXISTING UNDERGROUND UTILITIES SHALL BE LOCATED PRIOR TO COMMENCEMENT OF WORK. ANY UTILITY LINES THAT ARE NOT IN THE SCOPE OF THIS PROJECT THAT GETS DAMAGED AS OF RESULT OF THIS WORK SHALL BE REPAIRED AT CONTRACTOR'S EXPENSE.
- COORDINATE WITH OWNER ON DOWNTIME OF EXISTING SYSTEMS. ONE(1) RUNWAY SHALL REMAIN OPERATIONAL DURING THE DURATION OF OTHER RUNWAY BEING IN CONSTRUCTION.

PLAN NORTH **ED1** **AIRFIELD LIGHTING DEMOLITION PLAN - RUNWAY 5/23 - PART 1**
 SCALE: 1"=50'-0"

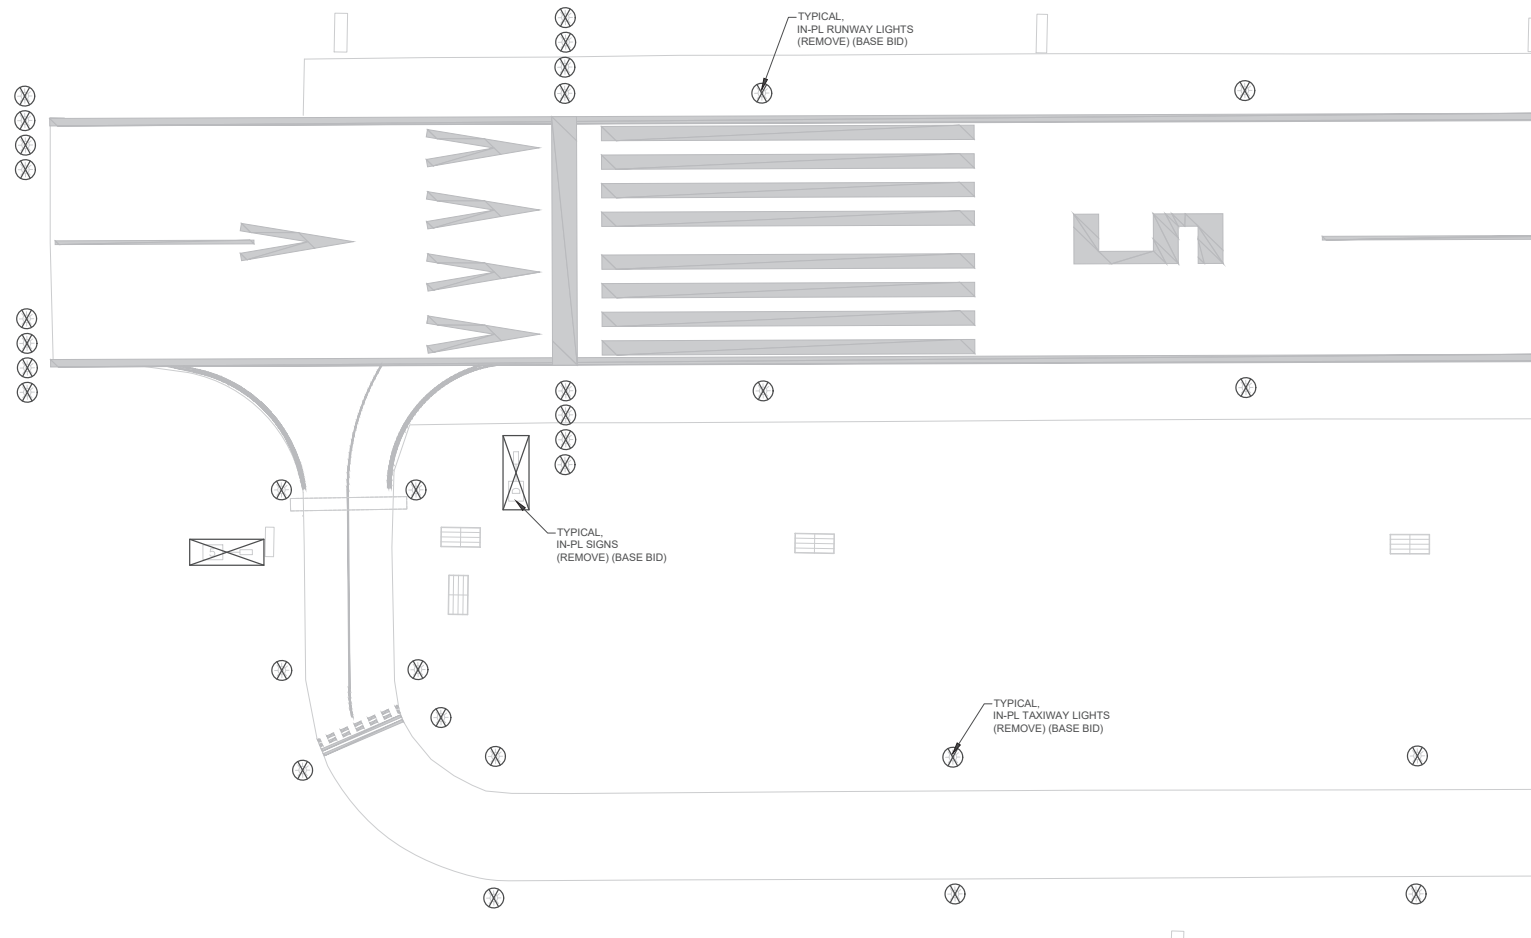

KEY PLAN
 TRUE NORTH NOT TO SCALE

VAUG220003

TYPICAL
IN-PL PAPI LIGHT UNIT
(REMOVE) (BASE BID)

TYPICAL
IN-PL RUNWAY LIGHTS
(REMOVE) (BASE BID)

TYPICAL
IN-PL SIGNS
(REMOVE) (BASE BID)

TYPICAL
IN-PL TAXIWAY LIGHTS
(REMOVE) (BASE BID)

GENERAL NOTES:
1. REFER TO SHEET GE1 FOR GENERAL ELECTRICAL DEMOLITION NOTES.

2. REMOVE ALL EXISTING RUNWAY LIGHTS, TAXIWAY LIGHTS, THRESHOLD LIGHTS, SIGNS, REILS, PAPI'S AND ASSOCIATED BASE CANS, TRANSFORMERS, AND CONCRETE PADS. RESTORE TURF AS REQUIRED. REMOVE ALL ASSOCIATED BURIED CABLES, COUNTER-POISES, CONDUCTORS, ANY CONDUITS THAT ARE ACCESSIBLE FOR REMOVAL, AND THOSE THAT ARE INACCESSIBLE SHALL BE ABANDONED IN-PLACE.


3. ALL EXISTING UNDERGROUND UTILITIES SHALL BE LOCATED PRIOR TO COMMENCEMENT OF WORK. ANY UTILITY LINES THAT ARE NOT IN THE SCOPE OF THIS PROJECT THAT GETS DAMAGED AS OF RESULT OF THIS WORK SHALL BE REPAIRED AT CONTRACTOR'S EXPENSE.

4. COORDINATE WITH OWNER ON DOWNTIME OF EXISTING SYSTEMS. ONE(1) RUNWAY SHALL REMAIN OPERATIONAL DURING THE DURATION OF OTHER RUNWAY BEING IN CONSTRUCTION.



AIRFIELD LIGHTING DEMOLITION PLAN - RUNWAY 5/23 - PART 2

SCALE: 1"=50'-0"

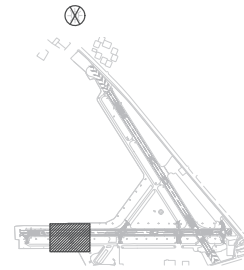

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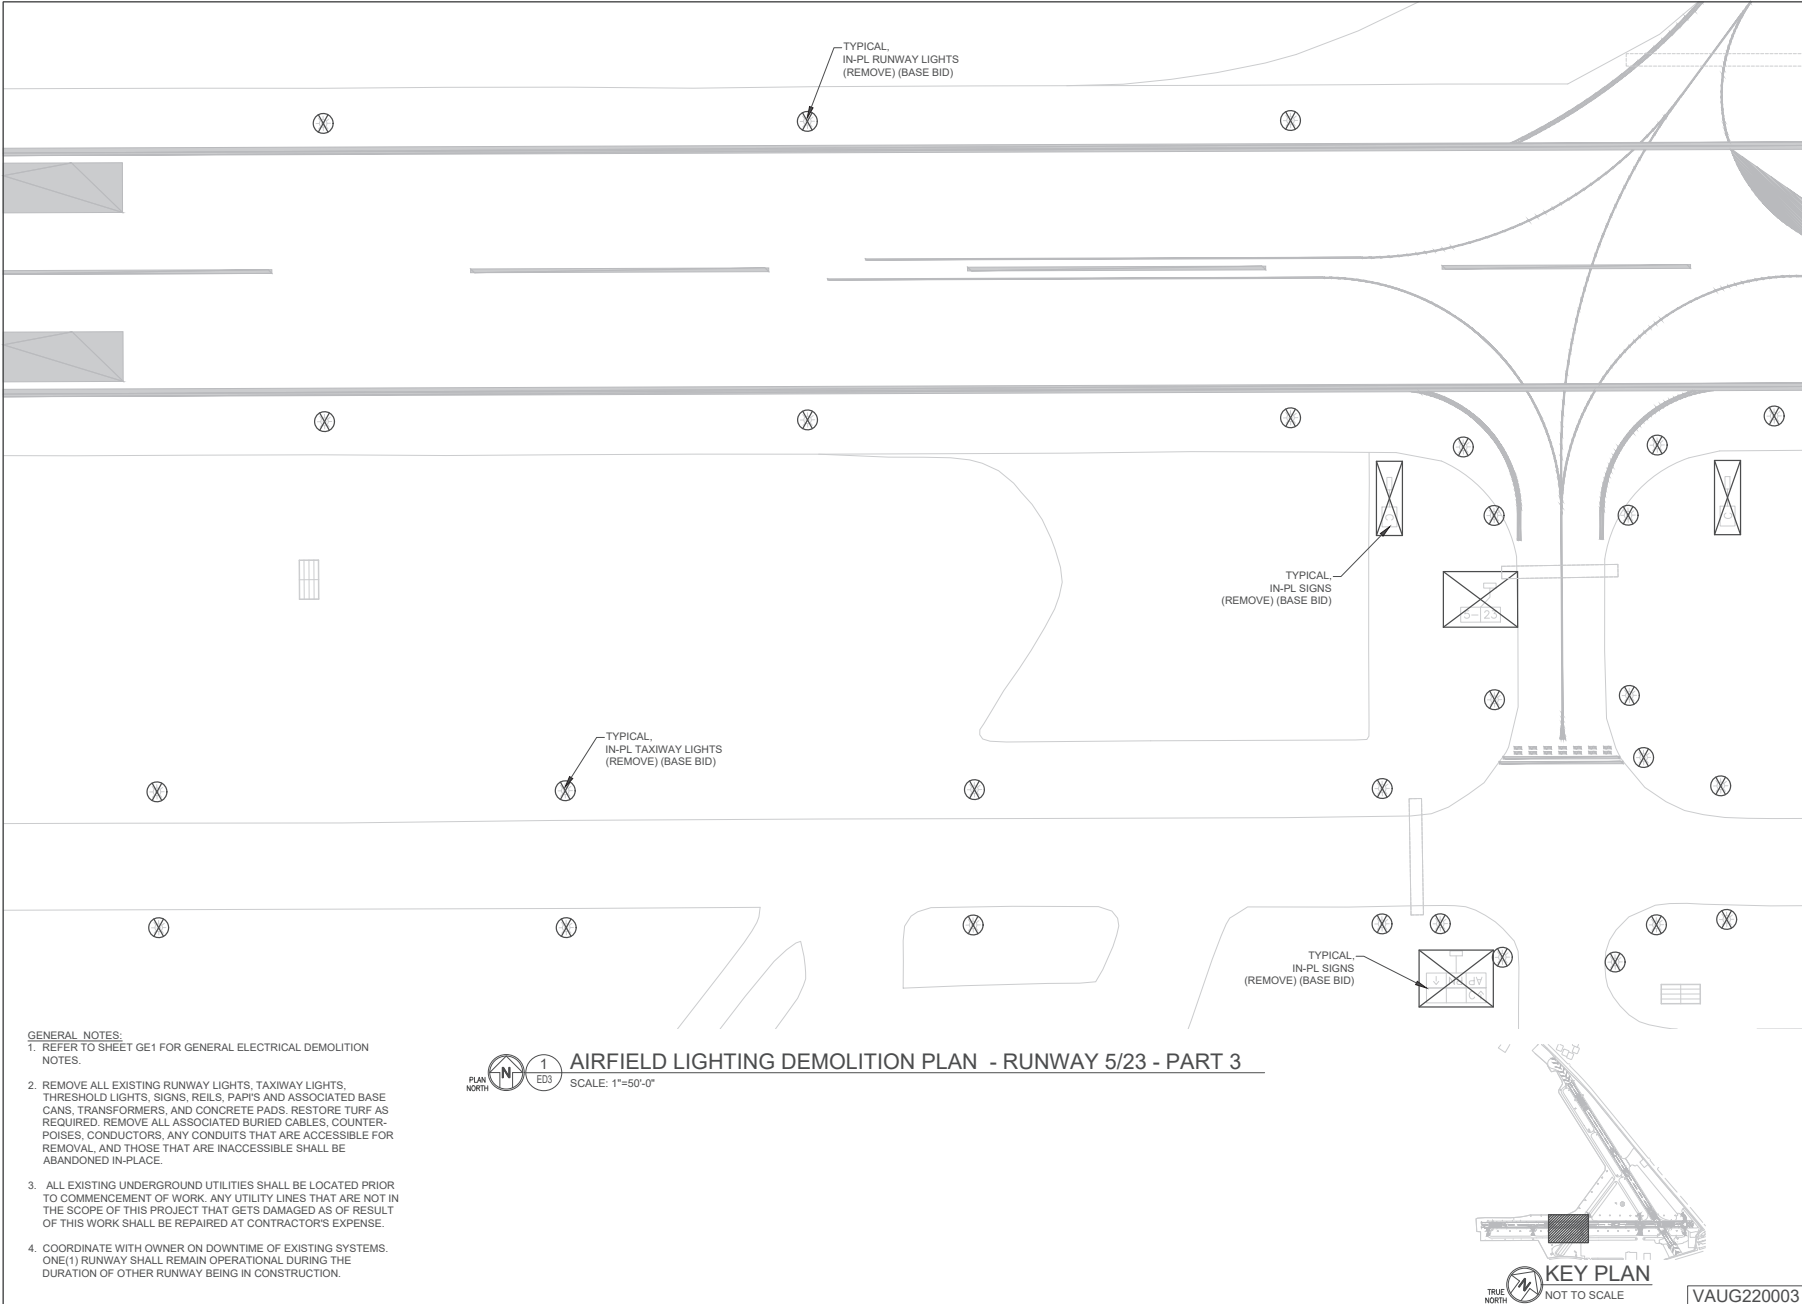
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**AIRFIELD ELECTRICAL UPGRADE
DANIEL FIELD AIRPORT (DNL)**
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AP019-XXX-XX(245)
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**AIRFIELD LIGHTING
DEMOLITION PLAN
RUNWAY 5/23 -
PART 2**
ED2
Sheet 14 of 52

VAUG220003




- GENERAL NOTES:**
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 2. REMOVE ALL EXISTING RUNWAY LIGHTS, TAXIWAY LIGHTS, THRESHOLD LIGHTS, SIGNS, REILS, PAPI'S AND ASSOCIATED BASE CANS, TRANSFORMERS, AND CONCRETE PADS. RESTORE TURF AS REQUIRED. REMOVE ALL ASSOCIATED BURIED CABLES, COUNTER-POISES, CONDUCTORS, ANY CONDUITS THAT ARE ACCESSIBLE FOR REMOVAL, AND THOSE THAT ARE INACCESSIBLE SHALL BE ABANDONED IN-PLACE.
 3. ALL EXISTING UNDERGROUND UTILITIES SHALL BE LOCATED PRIOR TO COMMENCEMENT OF WORK. ANY UTILITY LINES THAT ARE NOT IN THE SCOPE OF THIS PROJECT THAT GETS DAMAGED AS OF RESULT OF THIS WORK SHALL BE REPAIRED AT CONTRACTOR'S EXPENSE.
 4. COORDINATE WITH OWNER ON DOWNTIME OF EXISTING SYSTEMS. ONE(1) RUNWAY SHALL REMAIN OPERATIONAL DURING THE DURATION OF OTHER RUNWAY BEING IN CONSTRUCTION.

PLAN NORTH 1 ED3 SCALE: 1"=50'-0"

AIRFIELD LIGHTING DEMOLITION PLAN - RUNWAY 5/23 - PART 3

KEY PLAN
NOT TO SCALE

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


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**AIRFIELD ELECTRICAL UPGRADE
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**AIRFIELD LIGHTING
DEMOLITION PLAN
RUNWAY 5/23 -
PART 3**


ED3
Sheet 15 of 52



GENERAL NOTES:

1. REFER TO SHEET GE1 FOR GENERAL ELECTRICAL DEMOLITION NOTES.
2. REMOVE ALL EXISTING RUNWAY LIGHTS, TAXIWAY LIGHTS, THRESHOLD LIGHTS, SIGNS, REELS, PAPI'S AND ASSOCIATED BASE CANS, TRANSFORMERS, AND CONCRETE PADS. RESTORE TURF AS REQUIRED. REMOVE ALL ASSOCIATED BURIED CABLES, COUNTER-POISES, CONDUCTORS, ANY CONDUITS THAT ARE ACCESSIBLE FOR REMOVAL, AND THOSE THAT ARE INACCESSIBLE SHALL BE ABANDONED IN-PLACE.
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4. COORDINATE WITH OWNER ON DOWNTIME OF EXISTING SYSTEMS. ONE(1) RUNWAY SHALL REMAIN OPERATIONAL DURING THE DURATION OF OTHER RUNWAY BEING IN CONSTRUCTION.

AIRFIELD LIGHTING DEMOLITION PLAN - RUNWAY 5/23 - PART 4
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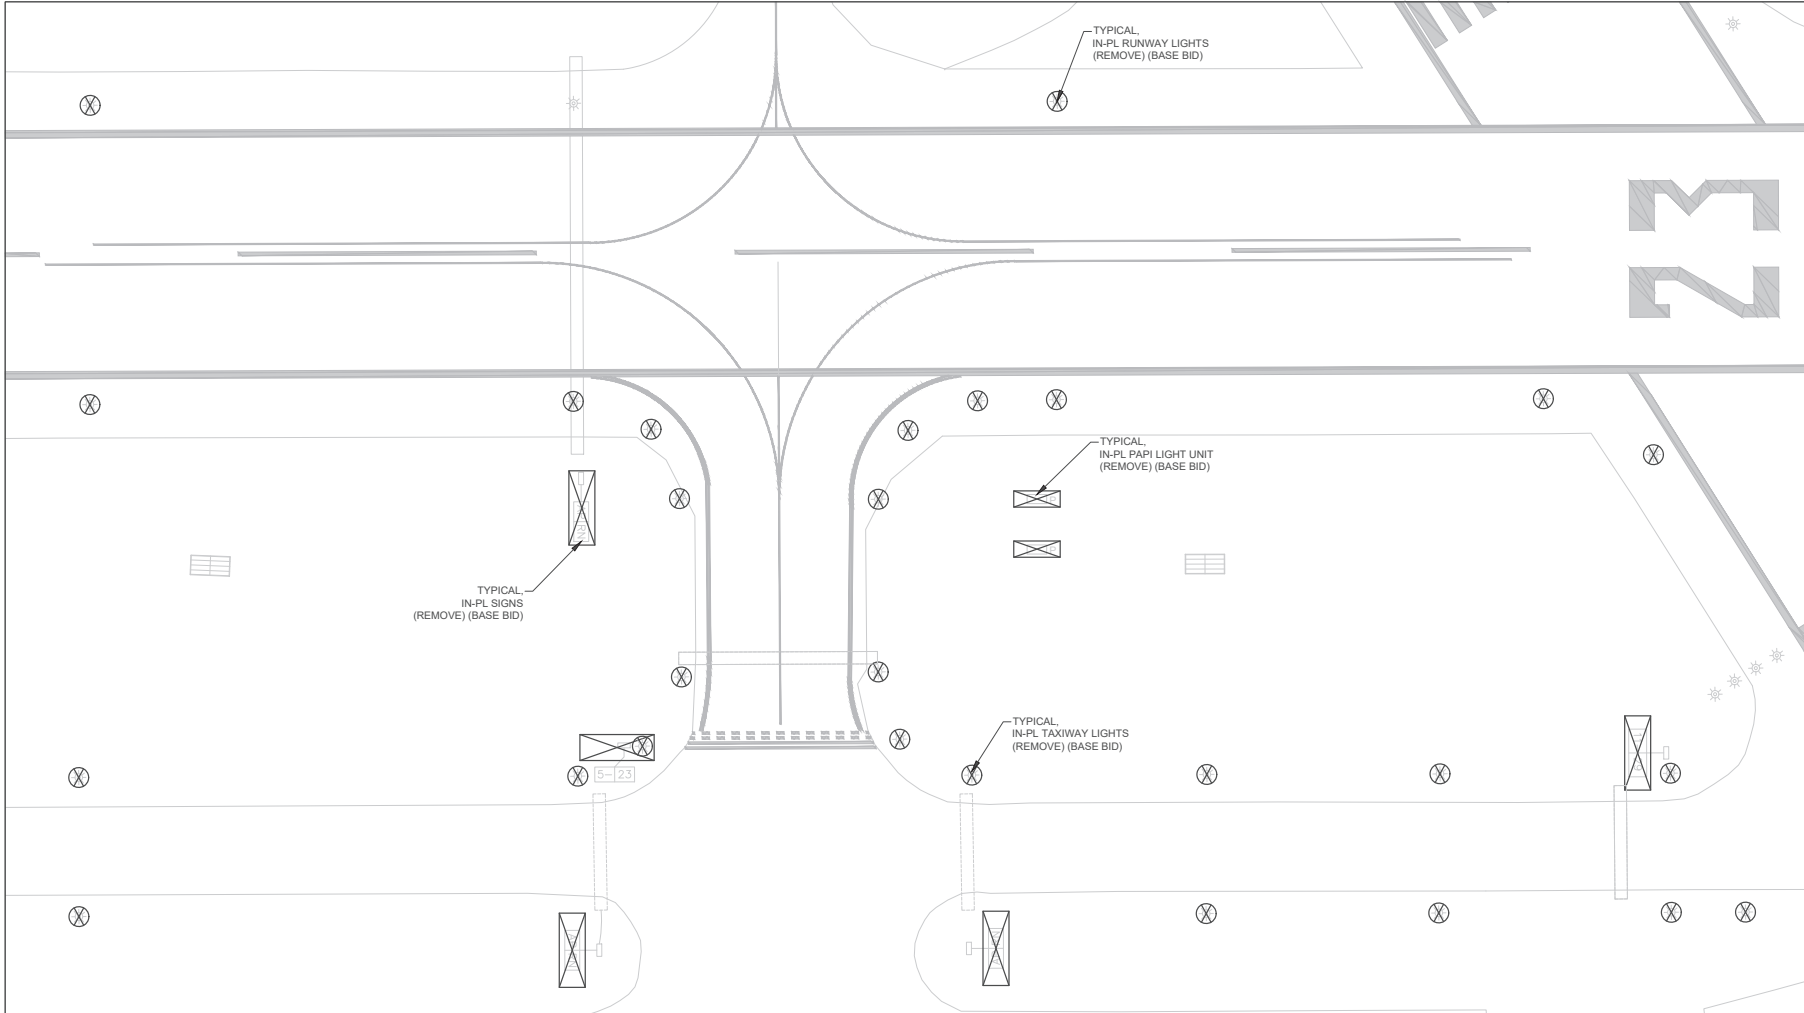
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**AIRFIELD LIGHTING
 DEMOLITION PLAN
 RUNWAY 5/23 -
 PART 4**

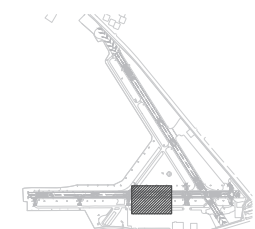ED4
 Sheet 16 of 52



GENERAL NOTES:
 1. REFER TO SHEET GE1 FOR GENERAL ELECTRICAL DEMOLITION NOTES.


2. REMOVE ALL EXISTING RUNWAY LIGHTS, TAXIWAY LIGHTS, THRESHOLD LIGHTS, SIGNS, REILS, PAPI'S AND ASSOCIATED BASE CANS, TRANSFORMERS, AND CONCRETE PADS. RESTORE TURF AS REQUIRED. REMOVE ALL ASSOCIATED BURIED CABLES, COUNTER-POISES, CONDUCTORS, ANY CONDUITS THAT ARE ACCESSIBLE FOR REMOVAL, AND THOSE THAT ARE INACCESSIBLE SHALL BE ABANDONED IN-PLACE.

3. ALL EXISTING UNDERGROUND UTILITIES SHALL BE LOCATED PRIOR TO COMMENCEMENT OF WORK. ANY UTILITY LINES THAT ARE NOT IN THE SCOPE OF THIS PROJECT THAT GETS DAMAGED AS OF RESULT OF THIS WORK SHALL BE REPAIRED AT CONTRACTOR'S EXPENSE.

4. COORDINATE WITH OWNER ON DOWNTIME OF EXISTING SYSTEMS. ONE(1) RUNWAY SHALL REMAIN OPERATIONAL DURING THE DURATION OF OTHER RUNWAY BEING IN CONSTRUCTION.

1 ED5
 PLAN NORTH SCALE: 1"=50'-0"

AIRFIELD LIGHTING DEMOLITION PLAN - RUNWAY 5/23 - PART 5

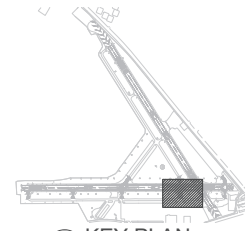

KEY PLAN
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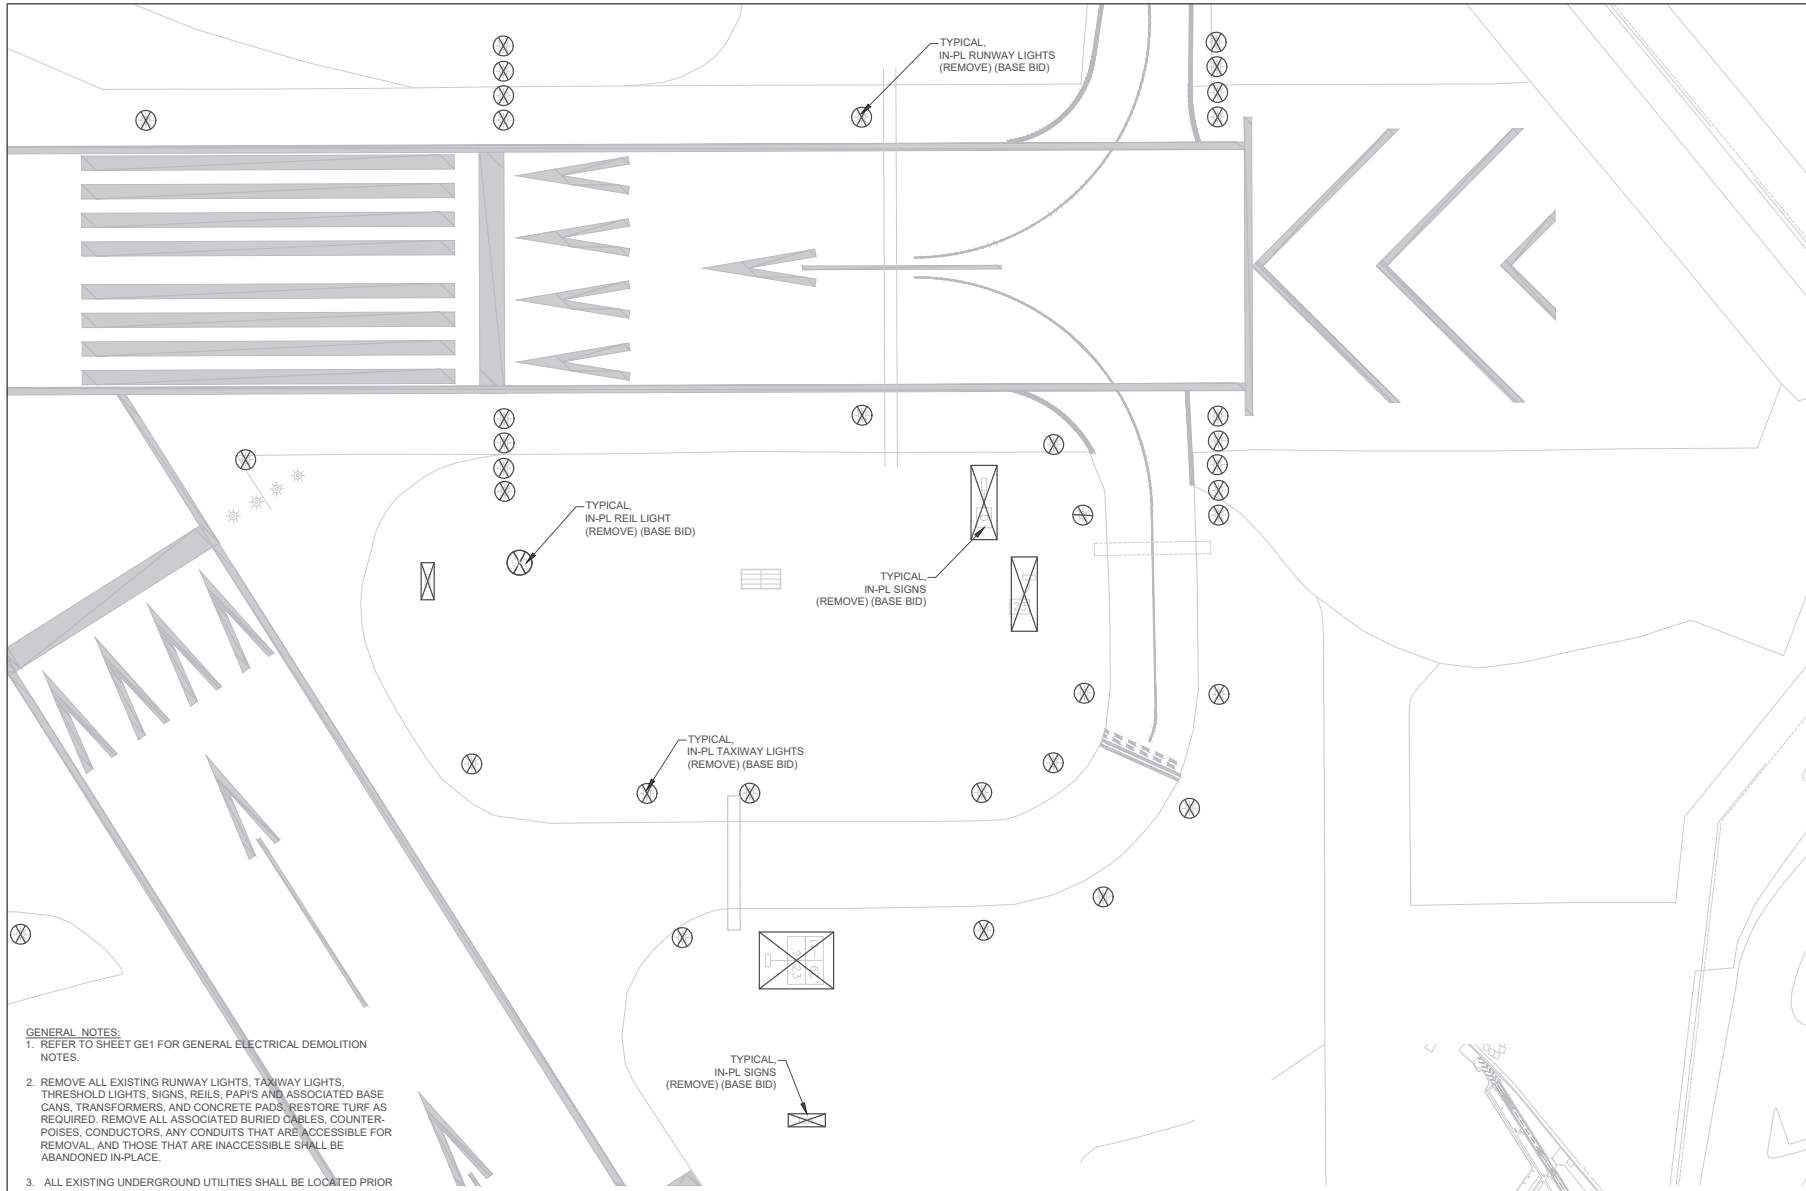
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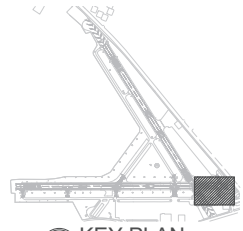
**AIRFIELD LIGHTING
 DEMOLITION PLAN
 RUNWAY 5/23 -
 PART 5**

ED5
 Sheet 17 of 52



- GENERAL NOTES:**
1. REFER TO SHEET GE1 FOR GENERAL ELECTRICAL DEMOLITION NOTES.
 2. REMOVE ALL EXISTING RUNWAY LIGHTS, TAXIWAY LIGHTS, THRESHOLD LIGHTS, SIGNS, REILS, PAPI'S AND ASSOCIATED BASE CANS, TRANSFORMERS, AND CONCRETE PADS. RESTORE TURF AS REQUIRED. REMOVE ALL ASSOCIATED BURIED CABLES, COUNTERPOISES, CONDUCTORS, ANY CONDUITS THAT ARE ACCESSIBLE FOR REMOVAL, AND THOSE THAT ARE INACCESSIBLE SHALL BE ABANDONED IN-PLACE.
 3. ALL EXISTING UNDERGROUND UTILITIES SHALL BE LOCATED PRIOR TO COMMENCEMENT OF WORK. ANY UTILITY LINES THAT ARE NOT IN THE SCOPE OF THIS PROJECT THAT GETS DAMAGED AS OF RESULT OF THIS WORK SHALL BE REPAIRED AT CONTRACTOR'S EXPENSE.
 4. COORDINATE WITH OWNER ON DOWNTIME OF EXISTING SYSTEMS. ONE(1) RUNWAY SHALL REMAIN OPERATIONAL DURING THE DURATION OF OTHER RUNWAY BEING IN CONSTRUCTION.

AIRFIELD LIGHTING DEMOLITION PLAN - RUNWAY 5/23 - PART 6
 SCALE: 1"=50'-0"



GMC

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ISSUE DATE	
TOOKS SUBMITTAL	1/20/2023
DESIGNED BY:	J.D.Z.
DRAWN BY:	J.R.A., J.D.Z.
CHECKED BY:	J.E.A.

**AIRFIELD ELECTRICAL UPGRADE
DANIEL FIELD AIRPORT (DNL)**

AUGUSTA, GEORGIA
AP019-XXX-XX(245)
GMC NUMBER : TAUG220004
SCALE: 1"=50'

**AIRFIELD LIGHTING
DEMOLITION PLAN
RUNWAY 5/23 -
PART 6**

ED6
Sheet 18 of 52


VAUG220003

GENERAL NOTES:

- REFER TO SHEET GE1 FOR GENERAL ELECTRICAL DEMOLITION NOTES.
- REMOVE ALL EXISTING RUNWAY LIGHTS, TAXIWAY LIGHTS, THRESHOLD LIGHTS, SIGNS, REILS, PAPI'S AND ASSOCIATED BASE CANS, TRANSFORMERS, AND CONCRETE PADS. RESTORE TURF AS REQUIRED. REMOVE ALL ASSOCIATED BURIED CABLES, COUNTER-POISES, CONDUCTORS, ANY CONDUITS THAT ARE ACCESSIBLE FOR REMOVAL, AND THOSE THAT ARE INACCESSIBLE SHALL BE ABANDONED IN-PLACE.
- ALL EXISTING UNDERGROUND UTILITIES SHALL BE LOCATED PRIOR TO COMMENCEMENT OF WORK. ANY UTILITY LINES THAT ARE NOT IN THE SCOPE OF THIS PROJECT THAT GETS DAMAGED AS OF RESULT OF THIS WORK SHALL BE REPAIRED AT CONTRACTOR'S EXPENSE.
- COORDINATE WITH OWNER ON DOWNTIME OF EXISTING SYSTEMS. ONE(1) RUNWAY SHALL REMAIN OPERATIONAL DURING THE DURATION OF OTHER RUNWAY BEING IN CONSTRUCTION.


KEYED NOTES (2):

- EXISTING ELECTRICAL CONNECTION TO WIND CONE TO BE REPLACED WITH NEW. DISCONNECT AND REMOVE ALL ELECTRICAL WIRING AND ELECTRICAL COMPONENTS ASSOCIATED WITH THE WIND CONE.
- EXISTING AWOS SYSTEM TO REMAIN IN SERVICE - NO WORK REQUIRED.

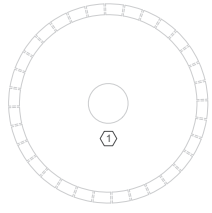

AIRFIELD LIGHTING DEMOLITION PLAN - EXISTING AWOS SYSTEM & WINDCONE

SCALE: 1"=50'-0"

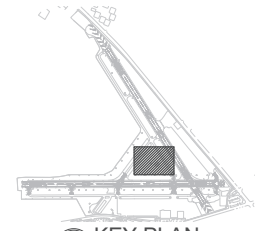

KEY PLAN
TRUE NORTH NOT TO SCALE



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DRAWN BY:	JRA, JDZ
CHECKED BY:	JEA

AIRFIELD ELECTRICAL UPGRADE DANIEL FIELD AIRPORT (DNL)

AUGUSTA, GEORGIA
 AP019-XXX-XX(245)
 GMC NUMBER : TAUG220004
 SCALE: 1"=50'




AIRFIELD LIGHTING DEMOLITION PLAN EXISTING AWOS & WINDCONE

ED7

Sheet 19 of 52

VAUG220003

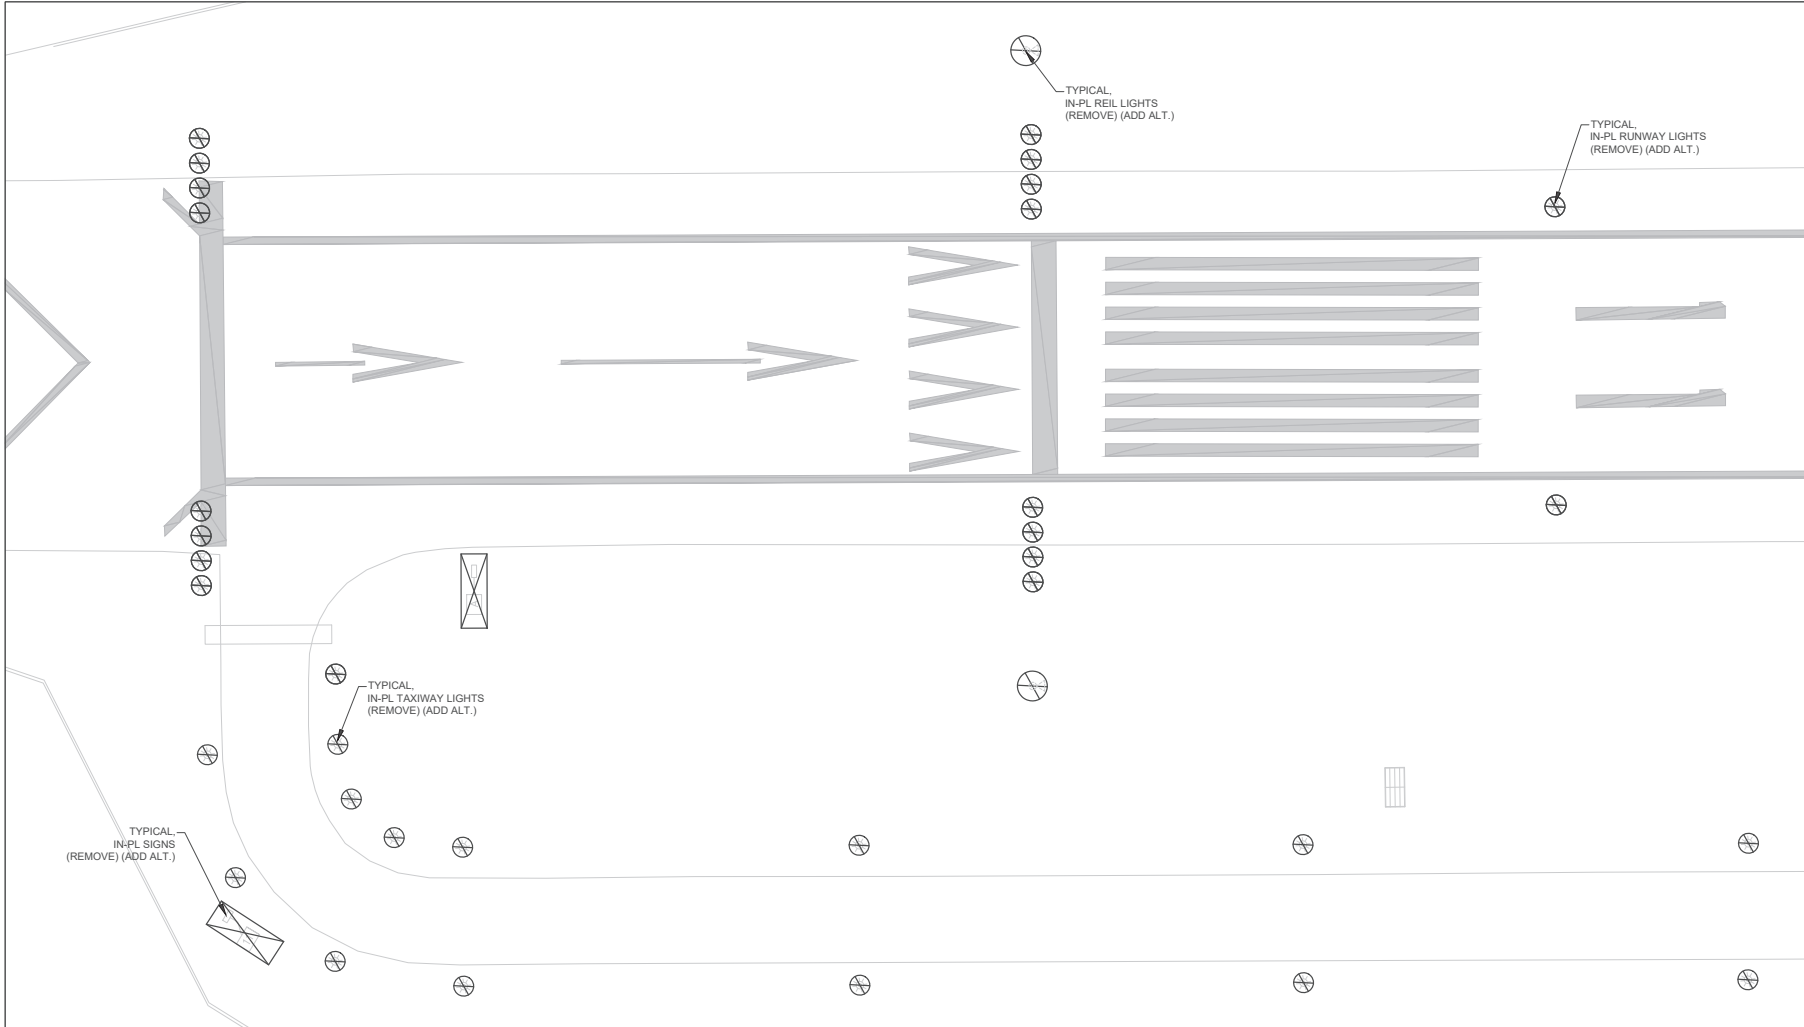


GENERAL NOTES:

1. REFER TO SHEET GE1 FOR GENERAL ELECTRICAL DEMOLITION NOTES.
2. REMOVE ALL EXISTING RUNWAY LIGHTS, TAXIWAY LIGHTS, THRESHOLD LIGHTS, SIGNS, REILS, PAPI'S AND ASSOCIATED BASE CANS, TRANSFORMERS, AND CONCRETE PADS. RESTORE TURF AS REQUIRED. REMOVE ALL ASSOCIATED BURIED CABLES, COUNTER-POISES, CONDUCTORS, ANY CONDUITS THAT ARE ACCESSIBLE FOR REMOVAL, AND THOSE THAT ARE INACCESSIBLE SHALL BE ABANDONED IN-PLACE.
3. ALL EXISTING UNDERGROUND UTILITIES SHALL BE LOCATED PRIOR TO COMMENCEMENT OF WORK. ANY UTILITY LINES THAT ARE NOT IN THE SCOPE OF THIS PROJECT THAT GETS DAMAGED AS OF RESULT OF THIS WORK SHALL BE REPAIRED AT CONTRACTOR'S EXPENSE.
4. COORDINATE WITH OWNER ON DOWNTIME OF EXISTING SYSTEMS. ONE(1) RUNWAY SHALL REMAIN OPERATIONAL DURING THE DURATION OF OTHER RUNWAY BEING IN CONSTRUCTION.




AIRFIELD LIGHTING DEMOLITION PLAN - RUNWAY 11/29 - PART 1 - ALTERNATE

SCALE: 1"=50'-0"

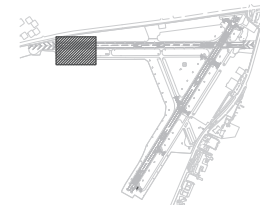

KEY PLAN
TRUE NORTH NOT TO SCALE

VAUG220003




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**AIRFIELD ELECTRICAL UPGRADE
DANIEL FIELD AIRPORT (DNL)**

AUGUSTA, GEORGIA
AP019-XXX-XX(245)
GMC NUMBER : TAUG220004
SCALE: 1"=50'




**AIRFIELD LIGHTING
DEMOLITION PLAN
RUNWAY 11-29 -
PART 1 (ALT)**

ED8
Sheet 20 of 52

GENERAL NOTES:

1. REFER TO SHEET GE1 FOR GENERAL ELECTRICAL DEMOLITION NOTES.
2. REMOVE ALL EXISTING RUNWAY LIGHTS, TAXIWAY LIGHTS, THRESHOLD LIGHTS, SIGNS, REELS, PAPI'S AND ASSOCIATED BASE CANS, TRANSFORMERS, AND CONCRETE PADS. RESTORE TURF AS REQUIRED. REMOVE ALL ASSOCIATED BURIED CABLES, COUNTER-POISES, CONDUCTORS, ANY CONDUITS THAT ARE ACCESSIBLE FOR REMOVAL, AND THOSE THAT ARE INACCESSIBLE SHALL BE ABANDONED IN-PLACE.
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4. COORDINATE WITH OWNER ON DOWNTIME OF EXISTING SYSTEMS. ONE(1) RUNWAY SHALL REMAIN OPERATIONAL DURING THE DURATION OF OTHER RUNWAY BEING IN CONSTRUCTION.

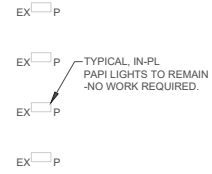

TYPICAL IN-PL PAPI LIGHTS TO REMAIN - NO WORK REQUIRED.


TYPICAL IN-PL RUNWAY LIGHTS (REMOVE) (ADD ALT.)

TYPICAL IN-PL SIGNS (REMOVE) (ADD ALT.)

TYPICAL IN-PL TAXIWAY LIGHTS (REMOVE) (ADD ALT.)

PLAN NORTH 1 ED9 SCALE: 1"=50'-0"

AIRFIELD LIGHTING DEMOLITION PLAN - RUNWAY 11/29 - PART 2 - ALTERNATE

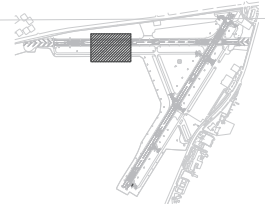

TRUE NORTH NOT TO SCALE

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AIRFIELD ELECTRICAL UPGRADE DANIEL FIELD AIRPORT (DNL)
AUGUSTA, GEORGIA
AP019-XXX-XX(245)
GMC NUMBER : TAUG220004
SCALE: 1"=50'



AIRFIELD LIGHTING DEMOLITION PLAN RUNWAY 11-29 - PART 2 (ALT)
ED9
Sheet 21 of 52

GENERAL NOTES:

1. REFER TO SHEET GE1 FOR GENERAL ELECTRICAL DEMOLITION NOTES.
2. REMOVE ALL EXISTING RUNWAY LIGHTS, TAXIWAY LIGHTS, THRESHOLD LIGHTS, SIGNS, REELS, PAPI'S AND ASSOCIATED BASE CANS, TRANSFORMERS, AND CONCRETE PADS. RESTORE TURF AS REQUIRED. REMOVE ALL ASSOCIATED BURIED CABLES, COUNTER-POISES, CONDUCTORS, ANY CONDUITS THAT ARE ACCESSIBLE FOR REMOVAL, AND THOSE THAT ARE INACCESSIBLE SHALL BE ABANDONED IN-PLACE.
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4. COORDINATE WITH OWNER ON DOWNTIME OF EXISTING SYSTEMS. ONE(1) RUNWAY SHALL REMAIN OPERATIONAL DURING THE DURATION OF OTHER RUNWAY BEING IN CONSTRUCTION.



KEY PLAN
TRUE NORTH NOT TO SCALE

TYPICAL IN-PL SIGNS (REMOVE) (ADD ALT.)

TYPICAL IN-PL SIGNS (REMOVE) (ADD ALT.)

TYPICAL IN-PL RUNWAY LIGHTS (REMOVE) (ADD ALT.)

TYPICAL IN-PL TAXIWAY LIGHTS (REMOVE) (ADD ALT.)



AIRFIELD LIGHTING DEMOLITION PLAN - RUNWAY 11/29 - PART 3 - ALTERNATE

SCALE: 1"=50'-0"

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AIRFIELD ELECTRICAL UPGRADE DANIEL FIELD AIRPORT (DNL)

AUGUSTA, GEORGIA
AP019-XXX-XX(245)
GMC NUMBER : TAUG220004
SCALE: 1"=50'




AIRFIELD LIGHTING DEMOLITION PLAN RUNWAY 11-29 - PART 3 (ALT)

ED10
Sheet 22 of 52

GENERAL NOTES:

- 1. REFER TO SHEET GE1 FOR GENERAL ELECTRICAL DEMOLITION NOTES.
- 2. REMOVE ALL EXISTING RUNWAY LIGHTS, TAXIWAY LIGHTS, THRESHOLD LIGHTS, SIGNS, REILS, PAPI'S AND ASSOCIATED BASE CANS, TRANSFORMERS, AND CONCRETE PADS. RESTORE TURF AS REQUIRED. REMOVE ALL ASSOCIATED BURIED CABLES, COUNTER-POISES, CONDUCTORS, ANY CONDUITS THAT ARE ACCESSIBLE FOR REMOVAL, AND THOSE THAT ARE INACCESSIBLE SHALL BE ABANDONED IN-PLACE.
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- 4. COORDINATE WITH OWNER ON DOWNTIME OF EXISTING SYSTEMS. ONE(1) RUNWAY SHALL REMAIN OPERATIONAL DURING THE DURATION OF OTHER RUNWAY BEING IN CONSTRUCTION.

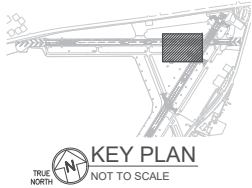

AIRFIELD LIGHTING DEMOLITION PLAN - RUNWAY 11/29 - PART 4 - ALTERNATE

SCALE: 1"=50'-0"

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CHECKED BY:	JEA

AIRFIELD ELECTRICAL UPGRADE
 DANIEL FIELD AIRPORT (DNL)

AUGUSTA, GEORGIA
 AP019-XXX-XX(245)
 GMC NUMBER : TAUG220004
 SCALE: 1"=50'




AIRFIELD LIGHTING
 DEMOLITION PLAN
 RUNWAY 11-29 -
 PART 4 (ALT)


ED11
 Sheet 23 of 52

GENERAL NOTES:

1. REFER TO SHEET GE1 FOR GENERAL ELECTRICAL DEMOLITION NOTES.
2. REMOVE ALL EXISTING RUNWAY LIGHTS, TAXIWAY LIGHTS, THRESHOLD LIGHTS, SIGNS, REILS, PAPI'S AND ASSOCIATED BASE CANS, TRANSFORMERS, AND CONCRETE PADS, RESTORE TURF AS REQUIRED. REMOVE ALL ASSOCIATED BURIED CABLES, COUNTER-POISES, CONDUCTORS, ANY CONDUITS THAT ARE ACCESSIBLE FOR REMOVAL, AND THOSE THAT ARE INACCESSIBLE SHALL BE ABANDONED IN-PLACE.
3. ALL EXISTING UNDERGROUND UTILITIES SHALL BE LOCATED PRIOR TO COMMENCEMENT OF WORK. ANY UTILITY LINES THAT ARE NOT IN THE SCOPE OF THIS PROJECT THAT GETS DAMAGED AS OF RESULT OF THIS WORK SHALL BE REPAIRED AT CONTRACTOR'S EXPENSE.
4. COORDINATE WITH OWNER ON DOWNTIME OF EXISTING SYSTEMS. ONE (1) RUNWAY SHALL REMAIN OPERATIONAL DURING THE DURATION OF OTHER RUNWAY BEING IN CONSTRUCTION.

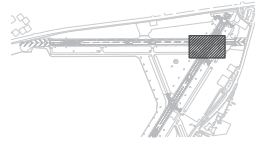


KEY PLAN
TRUE NORTH
NOT TO SCALE

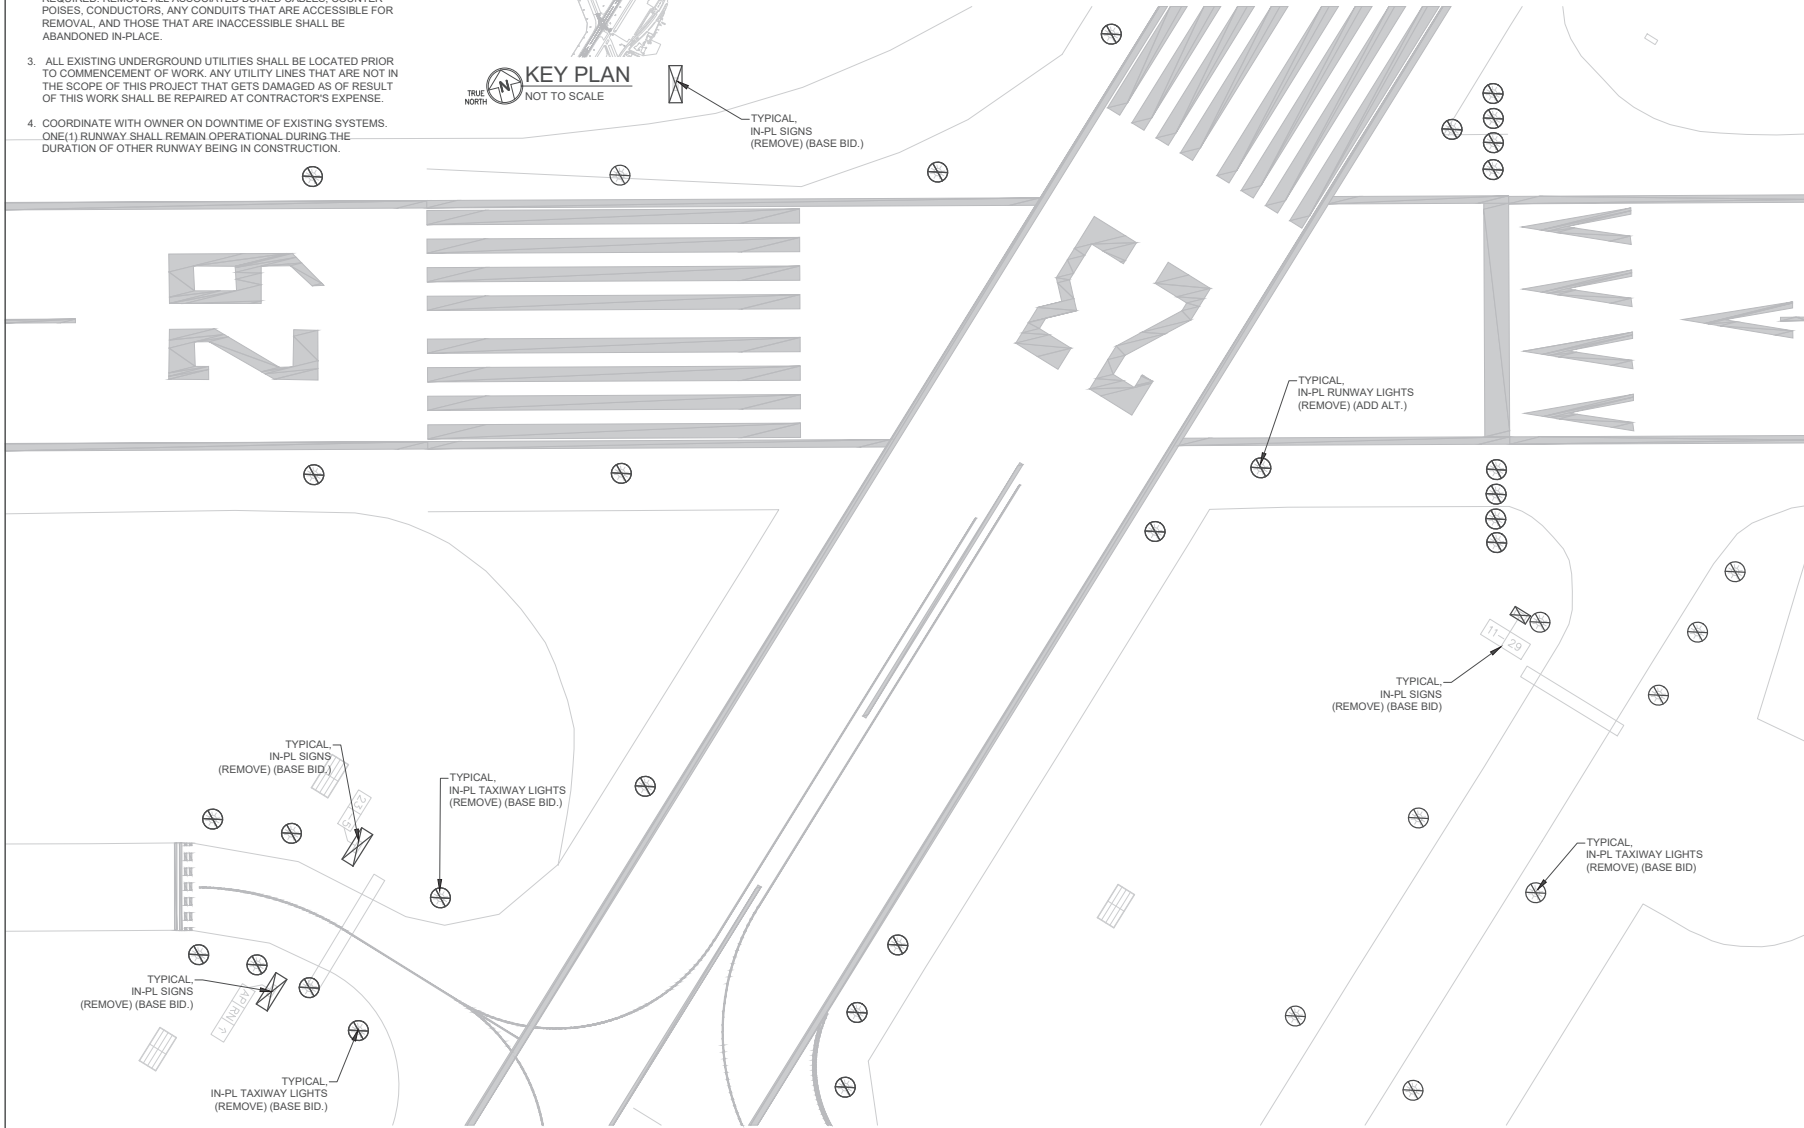

AIRFIELD LIGHTING DEMOLITION PLAN - RUNWAY 11/29 - PART 5 - ALTERNATE

SCALE: 1"=50'-0"

VAUG220003




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DESIGNED BY:	J.D.Z.
DRAWN BY:	J.R.A., J.D.Z.
CHECKED BY:	J.E.A.


**AIRFIELD ELECTRICAL UPGRADE
DANIEL FIELD AIRPORT (DNL)**

AUGUSTA, GEORGIA
AP019-XXX-XX(245)
GMC NUMBER : TAUG220004
SCALE: 1"=50'



**AIRFIELD LIGHTING
DEMOLITION PLAN
RUNWAY 11-29 -
PART 5 (ALT)**

ED12
Sheet 24 of 52

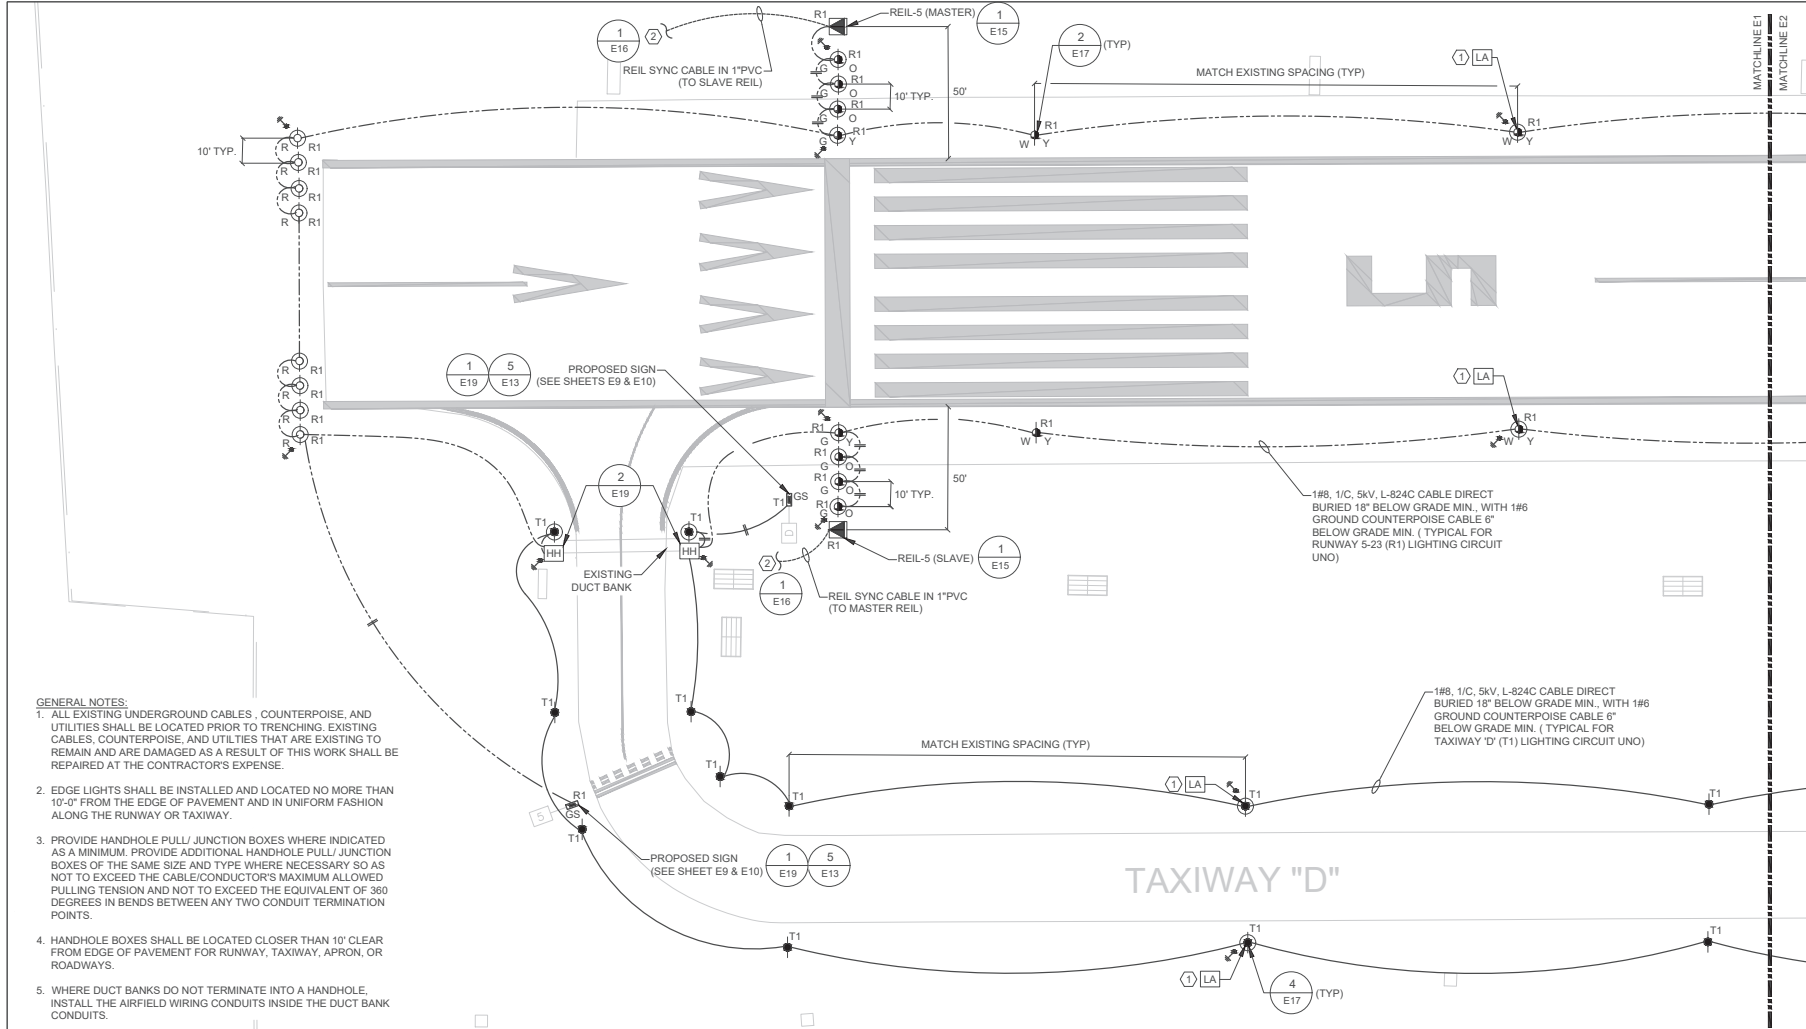

- GENERAL NOTES:**
1. ALL EXISTING UNDERGROUND CABLES, COUNTERPOISE, AND UTILITIES SHALL BE LOCATED PRIOR TO TRENCHING. EXISTING CABLES, COUNTERPOISE, AND UTILITIES THAT ARE EXISTING TO REMAIN AND ARE DAMAGED AS A RESULT OF THIS WORK SHALL BE REPAIRED AT THE CONTRACTOR'S EXPENSE.
 2. EDGE LIGHTS SHALL BE INSTALLED AND LOCATED NO MORE THAN 10'-0" FROM THE EDGE OF PAVEMENT AND IN UNIFORM FASHION ALONG THE RUNWAY OR TAXIWAY.
 3. PROVIDE HANDHOLE PULL JUNCTION BOXES WHERE INDICATED AS A MINIMUM. PROVIDE ADDITIONAL HANDHOLE PULL JUNCTION BOXES OF THE SAME SIZE AND TYPE WHERE NECESSARY SO AS NOT TO EXCEED THE CABLE/CONDUCTOR'S MAXIMUM ALLOWED PULLING TENSION AND NOT TO EXCEED THE EQUIVALENT OF 380 DEGREES IN BENDS BETWEEN ANY TWO CONDUIT TERMINATION POINTS.
 4. HANDHOLE BOXES SHALL BE LOCATED CLOSER THAN 10' CLEAR FROM EDGE OF PAVEMENT FOR RUNWAY, TAXIWAY, APRON, OR ROADWAYS.
 5. WHERE DUCT BANKS DO NOT TERMINATE INTO A HANDHOLE, INSTALL THE AIRFIELD WIRING CONDUITS INSIDE THE DUCT BANK CONDUITS.

- KEYED NOTES (#)**
1. PROVIDE FIELD LIGHTNING ARRESTOR FOR SERIES CIRCUIT AS SPECIFIED. LIGHTNING ARRESTOR TO BE ADB #FL44A6102 OR APPROVED EQUAL. INSTALL ARRESTOR IN THE BASE CAN INDICATED AND CONNECT TO THE SERIES LIGHTING CIRCUIT PER MANUFACTURER'S REQUIREMENTS. GROUND PER NEC AND FAA REGULATIONS. GROUND ARRESTOR TO BASE CAN THROUGH LUG USING A #4 COPPER GROUND CONDUCTOR. PROVIDE A RED TAG WITH WHITE "LA" LETTERS ON FIXTURE STEM. TAG SHALL MATCH DETAIL 3/E13 EXCEPT FOR THE COLOR.
 2. PROVIDE 12"x12"x12" HANDHOLES PER HANDHOLE DETAIL 2/E19. FOR REIL SYNC CABLE CONDUIT AS REQUIRED SO AS NOT TO EXCEED THE CABLE'S MAXIMUM ALLOWED PULLING TENSION AND NOT TO EXCEED THE EQUIVALENT OF 360 DEGREES IN BENDS BETWEEN ANY TWO CONDUIT TERMINATION POINTS.




AIRFIELD LIGHTING & WIRING PLAN - RUNWAY 5/23 - PART 1

SCALE: 1"=50'-0"

NOTE:

1. LOCATE ALL EXISTING UNDERGROUND UTILITIES, ELECTRICAL WIRING, IRRIGATION LINES, AND PIPING BEFORE DIGGING AND EXCAVATION FOR UNDERGROUND CONDUITS, BOXES, PAD EXCAVATION, GROUNDING, ETC. IN ADDITION, CONTACT LOCAL UTILITY COMPANY PROVIDER AND COORDINATE WITH OWNER 3-DAYS BEFORE DIGGING FOR MARKING THE UNDERGROUND UTILITIES. ANY EXISTING UTILITIES, PIPING, AND CABLES/CONDUITS SHOWN ON THESE PLANS ARE FOR GENERAL REFERENCE ONLY AND MAY NOT BE ACCURATE AS TO WHAT IS EXISTING ON SITE.

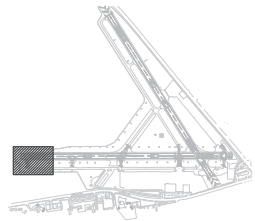

KEY PLAN
TRUE NORTH NOT TO SCALE

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100% SUBMITTAL	1/20/2023
designed by:	JDZ
drawn by:	JRA, JDZ
checked by:	JEA

**AIRFIELD ELECTRICAL UPGRADE
 DANIEL FIELD AIRPORT (DNL)**


AUGUSTA, GEORGIA
 AP019-XXX-XX(245)
 GMC NUMBER : TAUG220004
 SCALE: 1"=50'



**AIRFIELD LIGHTING
 & WIRING PLAN
 - RUNWAY 5/23
 -PART 1**

E1

Sheet 25 of 52

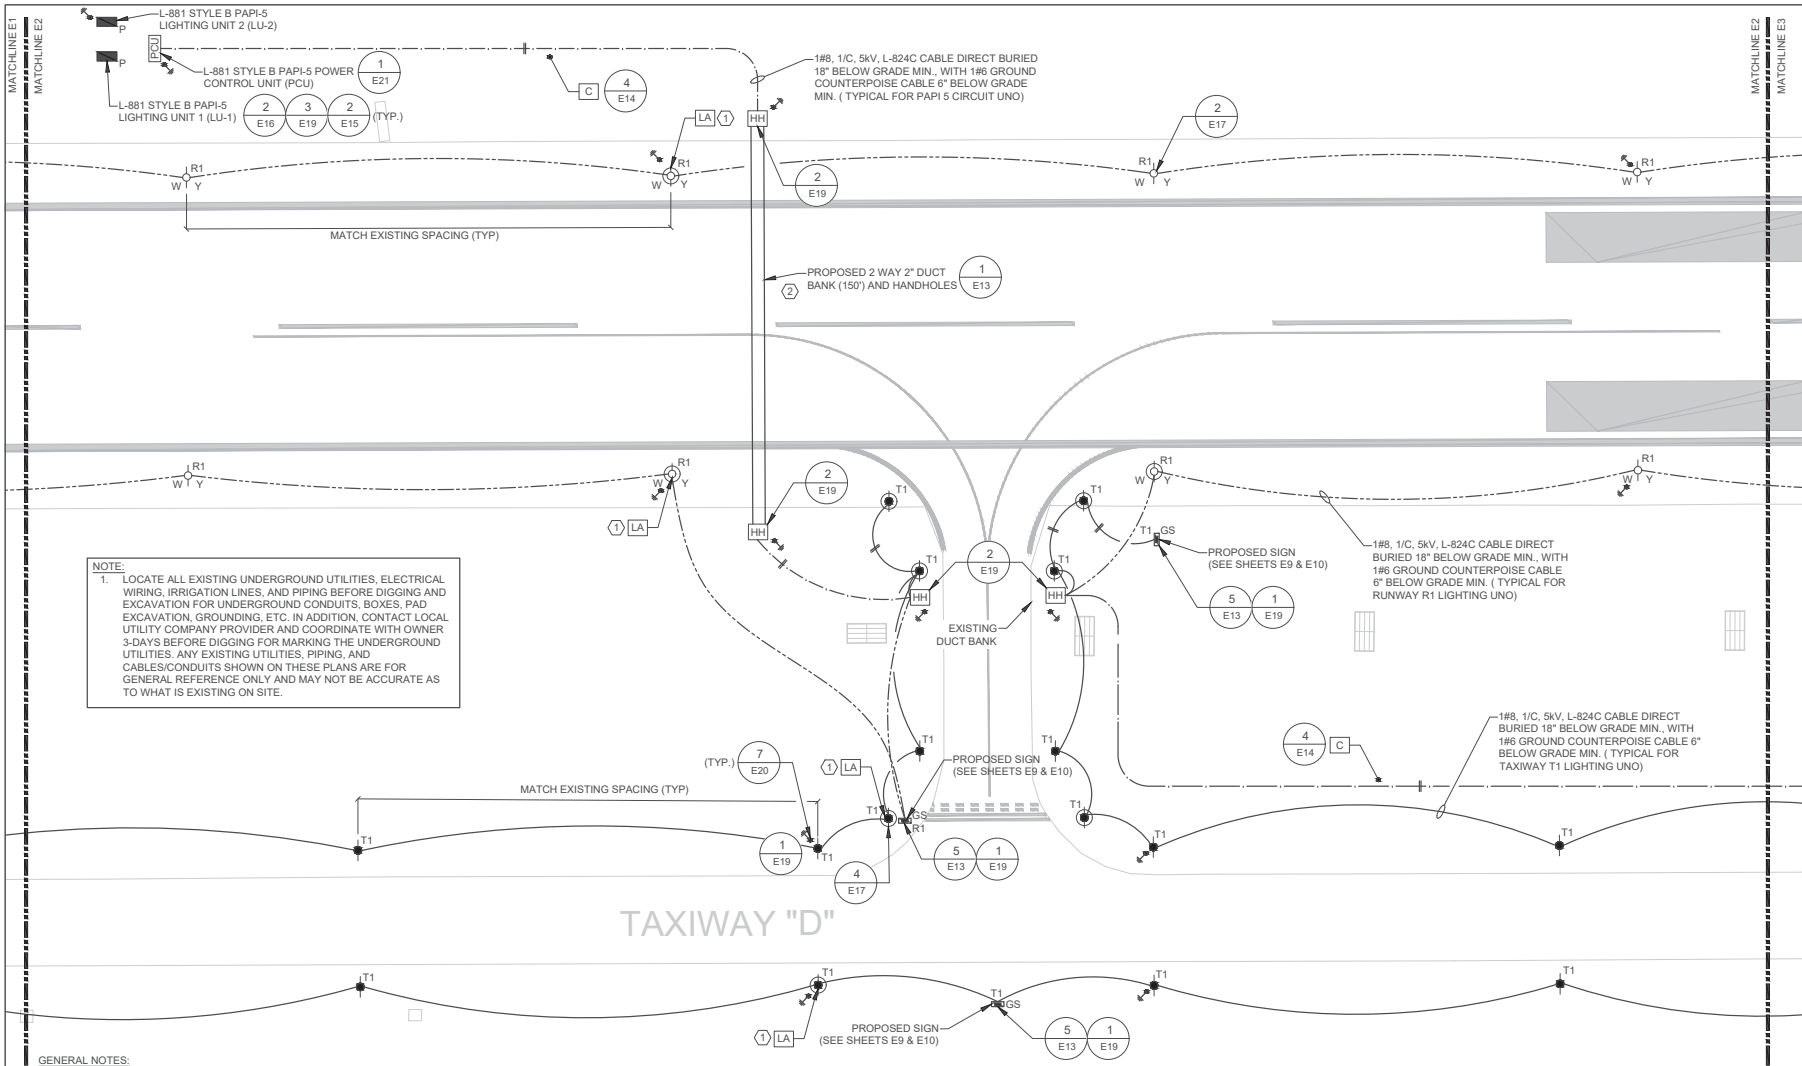


NOTE:
 1. LOCATE ALL EXISTING UNDERGROUND UTILITIES, ELECTRICAL WIRING, IRRIGATION LINES, AND PIPING BEFORE DIGGING AND EXCAVATION FOR UNDERGROUND CONDUITS, BOXES, PAD EXCAVATION, GROUNDING, ETC. IN ADDITION, CONTACT LOCAL UTILITY COMPANY PROVIDER AND COORDINATE WITH OWNER 3-DAYS BEFORE DIGGING FOR MARKING THE UNDERGROUND UTILITIES. ANY EXISTING UTILITIES, PIPING, AND CABLES/CONDUITS SHOWN ON THESE PLANS ARE FOR GENERAL REFERENCE ONLY AND MAY NOT BE ACCURATE AS TO WHAT IS EXISTING ON SITE.

- GENERAL NOTES:**
1. ALL EXISTING UNDERGROUND CABLES, COUNTERPOISE, AND UTILITIES SHALL BE LOCATED PRIOR TO TRENCHING. EXISTING CABLES, COUNTERPOISE, AND UTILITIES THAT ARE EXISTING TO REMAIN AND ARE DAMAGED AS A RESULT OF THIS WORK SHALL BE REPAIRED AT THE CONTRACTOR'S EXPENSE.
 2. EDGE LIGHTS SHALL BE INSTALLED AND LOCATED NO MORE THAN 10'-0" FROM THE EDGE OF PAVEMENT AND IN UNIFORM FASHION ALONG THE RUNWAY OR TAXIWAY.
 3. PROVIDE HANDHOLE PULL/JUNCTION BOXES WHERE INDICATED AS A MINIMUM. PROVIDE ADDITIONAL HANDHOLE PULL/JUNCTION BOXES OF THE SAME SIZE AND TYPE WHERE NECESSARY SO AS NOT TO EXCEED THE CABLE/CONDUCTOR'S MAXIMUM ALLOWED PULLING TENSION AND NOT TO EXCEED THE EQUIVALENT OF 360 DEGREES IN BENDS BETWEEN ANY TWO CONDUIT TERMINATION POINTS.
 4. HANDHOLE BOXES SHALL BE LOCATED CLOSER THAN 10' CLEAR FROM EDGE OF PAVEMENT FOR RUNWAY, TAXIWAY, APRON, OR ROADWAYS.
 5. WHERE DUCT BANKS DO NOT TERMINATE INTO A HANDHOLE, INSTALL THE AIRFIELD WIRING CONDUITS INSIDE THE DUCT BANK CONDUITS.

AIRFIELD LIGHTING & WIRING PLAN - RUNWAY 5/23 - PART 2
 SCALE: 1"=50'-0"

- KEYED NOTES (#)**
1. PROVIDE FIELD LIGHTNING ARRESTOR FOR SERIES CIRCUIT AS SPECIFIED. LIGHTING ARRESTOR TO BE ADB #FLA44A6102 OR APPROVED EQUAL. INSTALL ARRESTOR IN THE BASE CAN INDICATED AND CONNECT TO THE SERIES LIGHTING CIRCUIT PER MANUFACTURER'S REQUIREMENTS. GROUND PER NEG AND FAA REGULATIONS. GROUND ARRESTOR TO BASE CAN GROUND LUG USING A #4 COOPER GROUND CONDUCTOR. PROVIDE A RED TAG WITH WHITE "LA" LETTERS ON FIXTURE STEM. TAG SHALL MATCH DETAIL 3/E13 EXCEPT FOR THE COLOR.

2. CONTRACTOR TO FIELD VERIFY ANY EXISTING DUCT BANKS THAT CAN BE UTILIZED IN THE AREA FOR THE NEW PAPI-5 CIRCUIT. IF ONE DOES EXIST, CONTRACTOR SHALL SEND IN INFORMATION THROUGH RFI TO ENGINEER FOR APPROVAL. IF NEW DUCT BANK HAS TO BE INSTALLED, BORE UNDER EXISTING RUNWAY AS REQUIRED. COORDINATE WITH OWNER/PROJECT MANAGER PRIOR TO BEGINNING WORK.

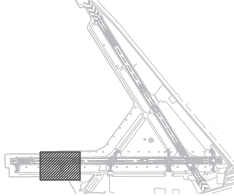

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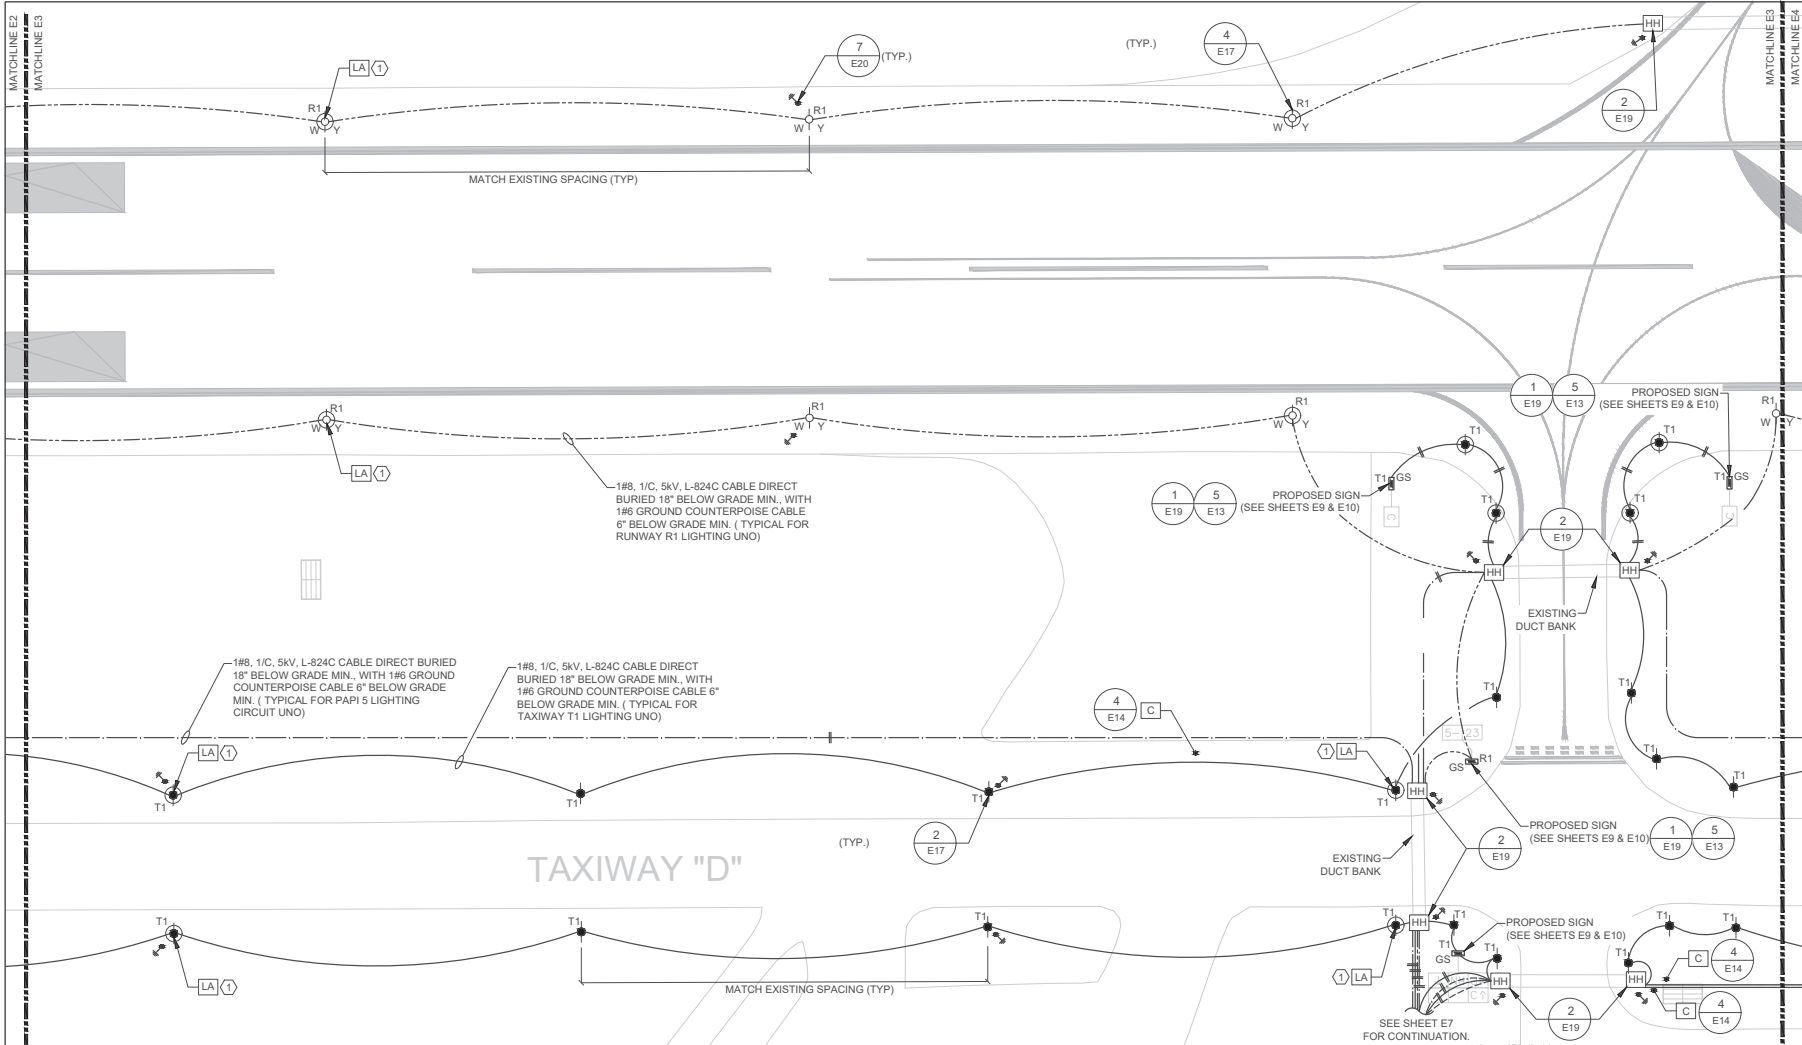
ISSUE DATE	
TOOCS SUBMITTAL	1/20/2023
DESIGNED BY	J.D.Z.
DRAWN BY	J.R.A., J.D.Z.
CHECKED BY	J.E.A.

**AIRFIELD ELECTRICAL UPGRADE
 DANIEL FIELD AIRPORT (DNL)**
 AUGUSTA, GEORGIA
 AP-019-XXX-XX(245)
 GMC NUMBER : TAUG220004
 SCALE: 1"=50'



**AIRFIELD LIGHTING
 & WIRING PLAN
 - RUNWAY 5/23
 - PART 2**
E2
 Sheet 26 of 52

VAUG220003



- GENERAL NOTES:**
1. ALL EXISTING UNDERGROUND CABLES, COUNTERPOISE, AND UTILITIES SHALL BE LOCATED PRIOR TO TRENCHING. EXISTING CABLES, COUNTERPOISE, AND UTILITIES THAT ARE EXISTING TO REMAIN AND ARE DAMAGED AS A RESULT OF THIS WORK SHALL BE REPAIRED AT THE CONTRACTOR'S EXPENSE.
 2. EDGE LIGHTS SHALL BE INSTALLED AND LOCATED NO MORE THAN 10'-0" FROM THE EDGE OF PAVEMENT AND IN UNIFORM FASHION ALONG THE RUNWAY OR TAXIWAY.
 3. PROVIDE HANDHOLE PULL/JUNCTION BOXES WHERE INDICATED AS A MINIMUM. PROVIDE ADDITIONAL HANDHOLE PULL/JUNCTION BOXES OF THE SAME SIZE AND TYPE WHERE NECESSARY SO AS NOT TO EXCEED THE CABLE/CONDUCTOR'S MAXIMUM ALLOWED PULLING TENSION AND NOT TO EXCEED THE EQUIVALENT OF 360 DEGREES IN BENDS BETWEEN ANY TWO CONDUIT TERMINATION POINTS.
 4. HANDHOLE BOXES SHALL BE LOCATED CLOSER THAN 10' CLEAR FROM EDGE OF PAVEMENT FOR RUNWAY, TAXIWAY, APRON, OR ROADWAYS.
 5. WHERE DUCT BANKS DO NOT TERMINATE INTO A HANDHOLE, INSTALL THE AIRFIELD WIRING CONDUITS INSIDE THE DUCT BANK CONDUITS.

AIRFIELD LIGHTING & WIRING PLAN - RUNWAY 5/23 - PART 3


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KEYED NOTES:

1. PROVIDE FIELD LIGHTNING ARRESTOR FOR SERIES CIRCUIT AS SPECIFIED. LIGHTING ARRESTOR TO BE ADB #FLA44A6102 OR APPROVED EQUAL. INSTALL ARRESTOR IN THE BASE CAN INDICATED AND CONNECT TO THE SERIES LIGHTING CIRCUIT PER MANUFACTURER'S REQUIREMENTS. GROUND PER NEC AND FAA REGULATIONS. GROUND ARRESTOR TO BASE CAN GROUND LUG USING A #4 COOPER GROUND CONDUCTOR. PROVIDE A RED TAG WITH WHITE "LA" LETTERS ON FIXTURE STEM. TAG SHALL MATCH DETAIL 3/E13 EXCEPT FOR THE COLOR.

NOTE:

1. LOCATE ALL EXISTING UNDERGROUND UTILITIES, ELECTRICAL WIRING, IRRIGATION LINES, AND PIPING BEFORE DIGGING AND EXCAVATION FOR UNDERGROUND CONDUITS, BOXES, PAD EXCAVATION, GROUNDING, ETC. IN ADDITION, CONTACT LOCAL UTILITY COMPANY PROVIDER AND COORDINATE WITH OWNER 3-DAYS BEFORE DIGGING FOR MARKING THE UNDERGROUND UTILITIES. ANY EXISTING UTILITIES, PIPING, AND CABLES/CONDUITS SHOWN ON THESE PLANS ARE FOR GENERAL REFERENCE ONLY AND MAY NOT BE ACCURATE AS TO WHAT IS EXISTING ON SITE.

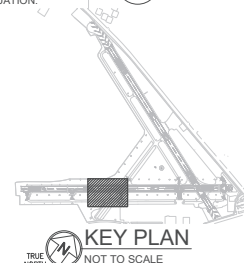

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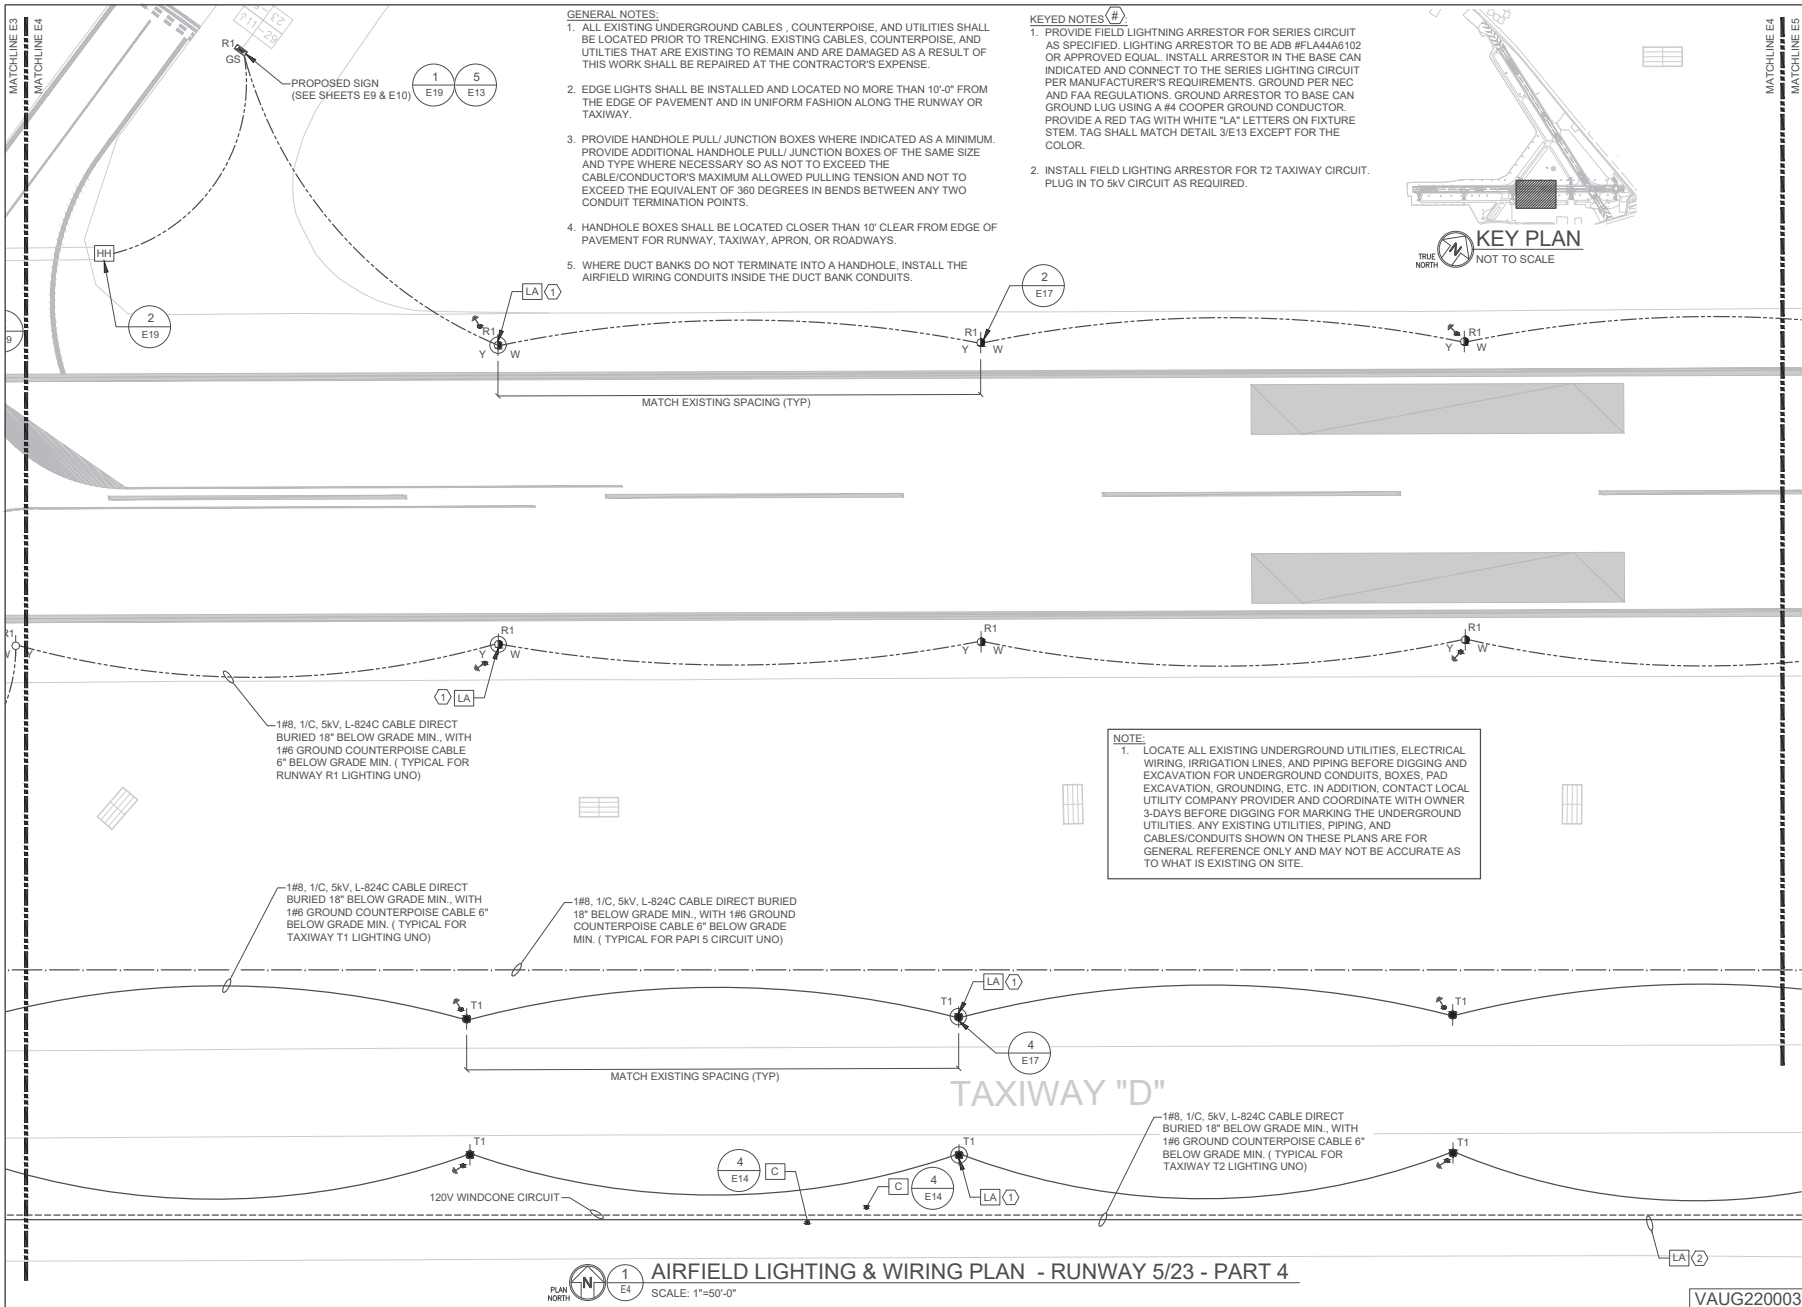
ISSUE DATE	
TOOKS SUBMITTAL	1/20/2023
DESIGNED BY:	J.D.Z.
DRAWN BY:	J.R.A., J.D.Z.
CHECKED BY:	J.E.A.

AIRFIELD LIGHTING & WIRING PLAN - RUNWAY 5/23 - PART 3

AUGUSTA, GEORGIA
AP019-XXX-XX(245)
GMC NUMBER : TAUG220004
SCALE: 1"=50'


E3

Sheet 27 of 52



- GENERAL NOTES:**
1. ALL EXISTING UNDERGROUND CABLES, COUNTERPOISE, AND UTILITIES SHALL BE LOCATED PRIOR TO TRENCHING. EXISTING CABLES, COUNTERPOISE, AND UTILITIES THAT ARE EXISTING TO REMAIN AND ARE DAMAGED AS A RESULT OF THIS WORK SHALL BE REPAIRED AT THE CONTRACTOR'S EXPENSE.
 2. EDGE LIGHTS SHALL BE INSTALLED AND LOCATED NO MORE THAN 10'-0" FROM THE EDGE OF PAVEMENT AND IN UNIFORM FASHION ALONG THE RUNWAY OR TAXIWAY.
 3. PROVIDE HANDHOLE PULL/JUNCTION BOXES WHERE INDICATED AS A MINIMUM. PROVIDE ADDITIONAL HANDHOLE PULL/JUNCTION BOXES OF THE SAME SIZE AND TYPE WHERE NECESSARY SO AS NOT TO EXCEED THE CABLE/CONDUCTOR'S MAXIMUM ALLOWED PULLING TENSION AND NOT TO EXCEED THE EQUIVALENT OF 360 DEGREES IN BENDS BETWEEN ANY TWO CONDUIT TERMINATION POINTS.
 4. HANDHOLE BOXES SHALL BE LOCATED CLOSER THAN 10' CLEAR FROM EDGE OF PAVEMENT FOR RUNWAY, TAXIWAY, APRON, OR ROADWAYS.
 5. WHERE DUCT BANKS DO NOT TERMINATE INTO A HANDHOLE, INSTALL THE AIRFIELD WIRING CONDUITS INSIDE THE DUCT BANK CONDUITS.

- KEYED NOTES (#)**
1. PROVIDE FIELD LIGHTNING ARRESTOR FOR SERIES CIRCUIT AS SPECIFIED. LIGHTNING ARRESTOR TO BE ADB #FL4446102 OR APPROVED EQUAL. INSTALL ARRESTOR IN THE BASE CAN INDICATED AND CONNECT TO THE SERIES LIGHTING CIRCUIT PER MANUFACTURER'S REQUIREMENTS. GROUND PER NEG AND FAA REGULATIONS. GROUND ARRESTOR TO BASE CAN GROUND LUG USING A #4 COOPER GROUND CONDUCTOR. PROVIDE A RED TAG WITH WHITE "LA" LETTERS ON FIXTURE STEM. TAG SHALL MATCH DETAIL 3/E13 EXCEPT FOR THE COLOR.
 2. INSTALL FIELD LIGHTNING ARRESTOR FOR T2 TAXIWAY CIRCUIT. PLUG IN TO 5kV CIRCUIT AS REQUIRED.

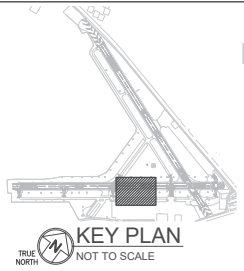

NOTE:

1. LOCATE ALL EXISTING UNDERGROUND UTILITIES, ELECTRICAL WIRING, IRRIGATION LINES, AND PIPING BEFORE DIGGING AND EXCAVATION FOR UNDERGROUND CONDUITS, BOXES, PAD EXCAVATION, GROUNDING, ETC. IN ADDITION, CONTACT LOCAL UTILITY COMPANY PROVIDER AND COORDINATE WITH OWNER 3-DAYS BEFORE DIGGING FOR MARKING THE UNDERGROUND UTILITIES. ANY EXISTING UTILITIES, PIPING, AND CABLES/CONDUITS SHOWN ON THESE PLANS ARE FOR GENERAL REFERENCE ONLY AND MAY NOT BE ACCURATE AS TO WHAT IS EXISTING ON SITE.

AIRFIELD LIGHTING & WIRING PLAN - RUNWAY 5/23 - PART 4
 SCALE: 1"=50'-0"



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DESIGNED BY:	JDZ
DRAWN BY:	JRA, JDZ
CHECKED BY:	JEA


AIRFIELD LIGHTING & WIRING PLAN - RUNWAY 5/23 - PART 4

AIRFIELD ELECTRICAL UPGRADE DANIEL FIELD AIRPORT (DNL)

AUGUSTA, GEORGIA
 AP019-XXX-XX(245)
 GMC NUMBER : TAUG220004
 SCALE: 1"=50'



E4
 Sheet 26 of 52

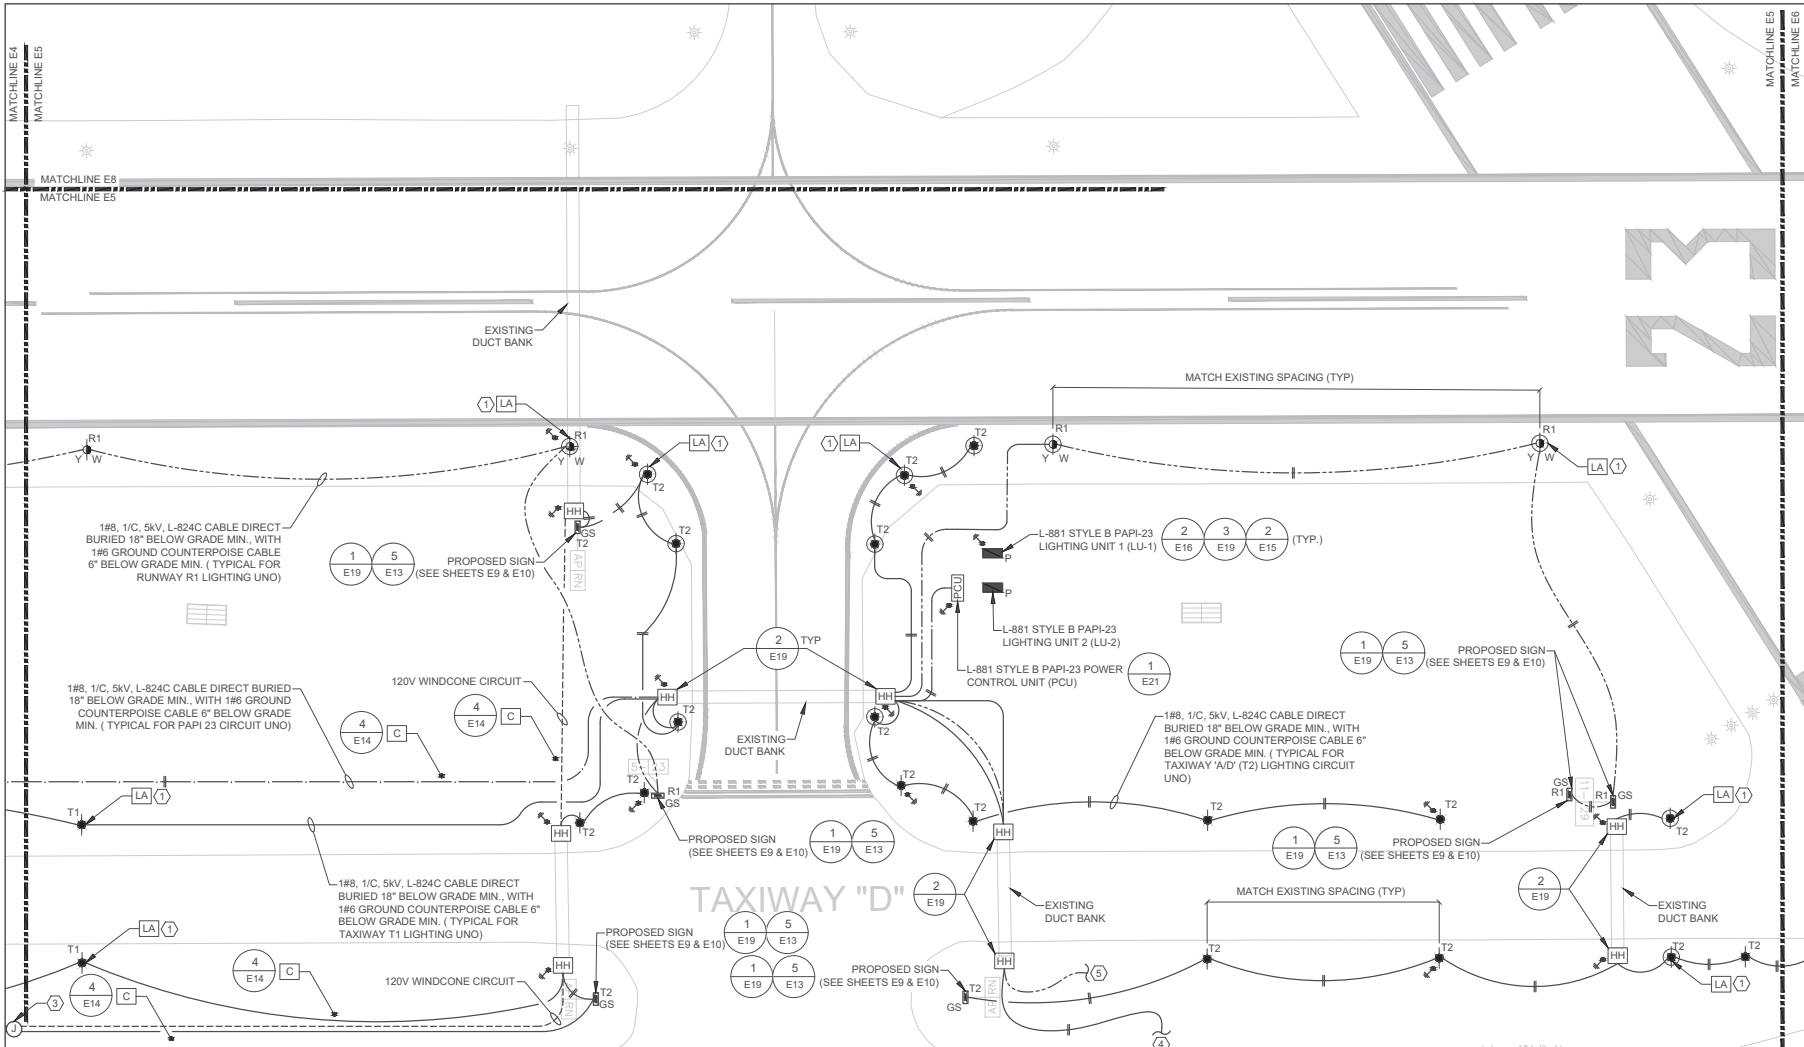


- GENERAL NOTES:**
- ALL EXISTING UNDERGROUND CABLES, COUNTERPOISE, AND UTILITIES SHALL BE LOCATED PRIOR TO TRENCHING. EXISTING CABLES, COUNTERPOISE, AND UTILITIES THAT ARE EXISTING TO REMAIN AND ARE DAMAGED AS A RESULT OF THIS WORK SHALL BE REPAIRED AT THE CONTRACTOR'S EXPENSE.
 - EDGE LIGHTS SHALL BE INSTALLED AND LOCATED NO MORE THAN 10'-0" FROM THE EDGE OF PAVEMENT AND IN UNIFORM FASHION ALONG THE RUNWAY OR TAXIWAY.
 - PROVIDE HANDHOLE PULL/JUNCTION BOXES WHERE INDICATED AS A MINIMUM. PROVIDE ADDITIONAL HANDHOLE PULL/JUNCTION BOXES OF THE SAME SIZE AND TYPE WHERE NECESSARY SO AS NOT TO EXCEED THE CABLE/CONDUCTOR'S MAXIMUM ALLOWED PULLING TENSION AND NOT TO EXCEED THE EQUIVALENT OF 360 DEGREES IN BENDS BETWEEN ANY TWO CONDUIT TERMINATION POINTS.
 - HANDHOLE BOXES SHALL BE LOCATED CLOSER THAN 10' CLEAR FROM EDGE OF PAVEMENT FOR RUNWAY, TAXIWAY, APRON, OR ROADWAYS.
 - WHERE DUCT BANKS DO NOT TERMINATE INTO A HANDHOLE, INSTALL THE AIRFIELD WIRING CONDUITS INSIDE THE DUCT BANK CONDUITS.

- KEYED NOTES:**
- PROVIDE FIELD LIGHTNING ARRESTOR FOR SERIES CIRCUIT AS SPECIFIED. LIGHTNING ARRESTOR TO BE ADB #FLA44A6102 OR APPROVED EQUAL. INSTALL ARRESTOR IN THE BASE CAN INDICATED AND CONNECT TO THE SERIES LIGHTING CIRCUIT PER MANUFACTURER'S REQUIREMENTS. GROUND PER NEC AND FAA REGULATIONS. GROUND ARRESTOR TO BASE CAN GROUND LUG USING A #4 COPPER GROUND CONDUCTOR. PROVIDE A RED TAG WITH WHITE "LA" LETTERS ON FIXTURE STEM. TAG SHALL MATCH DETAIL 3/E13 EXCEPT FOR THE COLOR.
 - SEE SHEET E8 FOR CONTINUATION OF 120V WIND CONE CIRCUIT.
 - EXISTING JUNCTION BOX/CAN TO REMAIN.
 - SEE SHEET E6 FOR TAXIWAY T1 CIRCUIT CONTINUATION. MATCH EXISTING ROUTE.
 - SEE SHEET E6 FOR RUNWAY R1 CIRCUIT CONTINUATION. MATCH EXISTING ROUTE.

NOTE:

- LOCATE ALL EXISTING UNDERGROUND UTILITIES, ELECTRICAL WIRING, IRRIGATION LINES, AND PIPING BEFORE DIGGING AND EXCAVATION FOR UNDERGROUND CONDUITS, BOXES, PAD EXCAVATION, GROUNDING, ETC. IN ADDITION, CONTACT LOCAL UTILITY COMPANY PROVIDER AND COORDINATE WITH OWNER 3-DAYS BEFORE DIGGING FOR MARKING THE UNDERGROUND UTILITIES. ANY EXISTING UTILITIES, PIPING, AND CABLES/CONDUITS SHOWN ON THESE PLANS ARE FOR GENERAL REFERENCE ONLY AND MAY NOT BE ACCURATE AS TO WHAT IS EXISTING ON SITE.

AIRFIELD LIGHTING & WIRING PLAN - RUNWAY 5/23 - PART 5
 SCALE: 1"=50'-0"

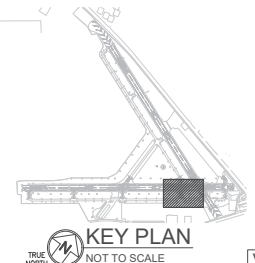

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DRAWN BY:	JRA, JAZ
CHECKED BY:	JEA


AIRFIELD LIGHTING & WIRING PLAN - RUNWAY 5/23 - PART 5

AP019-XXX-XX(245)

GMC NUMBER : TAUG220004

SCALE: 1"=50'



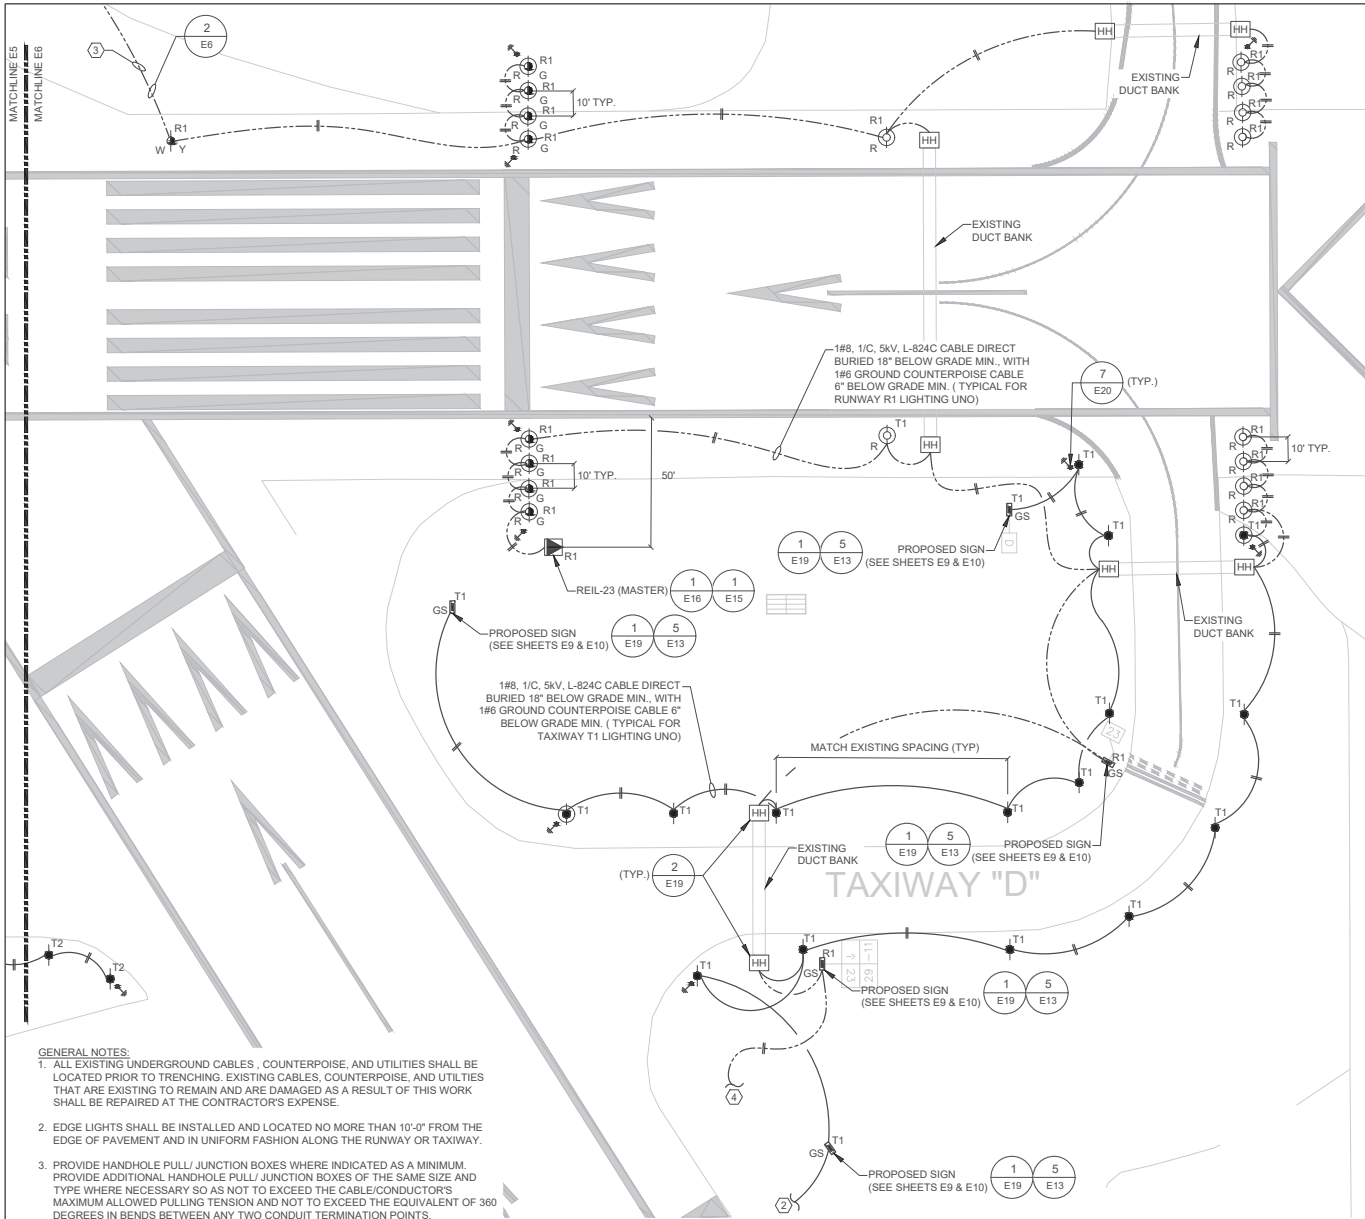

GENERAL NOTES:

1. ALL EXISTING UNDERGROUND CABLES, COUNTERPOISE, AND UTILITIES SHALL BE LOCATED PRIOR TO TRENCHING. EXISTING CABLES, COUNTERPOISE, AND UTILITIES THAT ARE EXISTING TO REMAIN AND ARE DAMAGED AS A RESULT OF THIS WORK SHALL BE REPAIRED AT THE CONTRACTOR'S EXPENSE.
2. EDGE LIGHTS SHALL BE INSTALLED AND LOCATED NO MORE THAN 10'-0" FROM THE EDGE OF PAVEMENT AND IN UNIFORM FASHION ALONG THE RUNWAY OR TAXIWAY.
3. PROVIDE HANDHOLE PULL/JUNCTION BOXES WHERE INDICATED AS A MINIMUM. PROVIDE ADDITIONAL HANDHOLE PULL/JUNCTION BOXES OF THE SAME SIZE AND TYPE WHERE NECESSARY SO AS NOT TO EXCEED THE CABLE/CONDUCTOR'S MAXIMUM ALLOWED PULLING TENSION AND NOT TO EXCEED THE EQUIVALENT OF 360 DEGREES IN BENDS BETWEEN ANY TWO CONDUIT TERMINATION POINTS.
4. HANDHOLE BOXES SHALL BE LOCATED CLOSER THAN 10' CLEAR FROM EDGE OF PAVEMENT FOR RUNWAY, TAXIWAY, APRON, OR ROADWAYS.
5. WHERE DUCT BANKS DO NOT TERMINATE INTO A HANDHOLE, INSTALL THE AIRFIELD WIRING CONDUITS INSIDE THE DUCT BANK CONDUITS.



AIRFIELD LIGHTING & WIRING PLAN - RUNWAY 5/23 - PART 6
SCALE: 1"=50'-0"

KEYED NOTES


1. PROVIDE FIELD LIGHTNING ARRESTOR FOR SERIES CIRCUIT AS SPECIFIED LIGHTING ARRESTOR TO BE ADB #FLA446102 OR APPROVED EQUAL. INSTALL ARRESTOR IN THE BASE CAN INDICATED AND CONNECT TO THE SERIES LIGHTING CIRCUIT PER MANUFACTURER'S REQUIREMENTS. GROUND PER NEC AND FAA REGULATIONS. GROUND ARRESTOR TO BASE CAN GROUND LUG USING A #4 COOPER GROUND CONDUCTOR. PROVIDE A RED TAG WITH WHITE "LA" LETTERS ON FIXTURE STEM. TAG SHALL MATCH DETAIL 3/E17 EXCEPT FOR THE COLOR.
2. SEE SHEET E5 FOR CONTINUATION OF TAXIWAY 'D' (T1) CIRCUIT. ROUTE CIRCUIT AROUND RUNWAY 11/29 THRESHOLD AS REQUIRED. MATCH EXISTING ROUTE.
3. SEE DETAIL 2/E6 (THIS SHEET) FOR CONTINUATION OF RUNWAY 5-23 (R1) CIRCUIT. MATCH EXISTING ROUTE.
4. SEE SHEET E5 FOR CONTINUATION OF RUNWAY R1 CIRCUIT. ROUTE CIRCUIT AROUND RUNWAY 11/29 THRESHOLD AS REQUIRED. MATCH EXISTING ROUTE.



AIRFIELD LIGHTING & WIRING PLAN - RUNWAY 5/23 - PART 6
SCALE: 1"=50'-0"

NOTE:

1. LOCATE ALL EXISTING UNDERGROUND UTILITIES, ELECTRICAL WIRING, IRRIGATION LINES, AND PIPING BEFORE DIGGING AND EXCAVATION FOR UNDERGROUND CONDUITS, BOXES, PAD EXCAVATION, GROUNDING, ETC. IN ADDITION, CONTACT LOCAL UTILITY COMPANY PROVIDER AND COORDINATE WITH OWNER 3-DAYS BEFORE DIGGING FOR MARKING THE UNDERGROUND UTILITIES. ANY EXISTING UTILITIES, PIPING, AND CABLES/CONDUITS SHOWN ON THESE PLANS ARE FOR GENERAL REFERENCE ONLY AND MAY NOT BE ACCURATE AS TO WHAT IS EXISTING ON SITE.

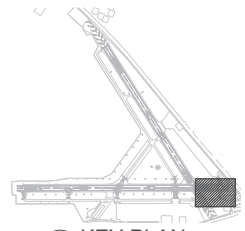

KEY PLAN
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TOOCS SUBMITTAL	1/20/2023

designed by: J.D.Z.
drawn by: J.R.A., J.D.Z.
checked by: J.E.A.


**AIRFIELD ELECTRICAL UPGRADE
DANIEL FIELD AIRPORT (DNL)**

AUGUSTA, GEORGIA
AP019-XXX-XX(245)
GMC NUMBER : TAUG220004
SCALE: 1"=50'

**AIRFIELD LIGHTING
& WIRING PLAN
- RUNWAY 5/23
- PART 6**

E6
Sheet 30 of 52



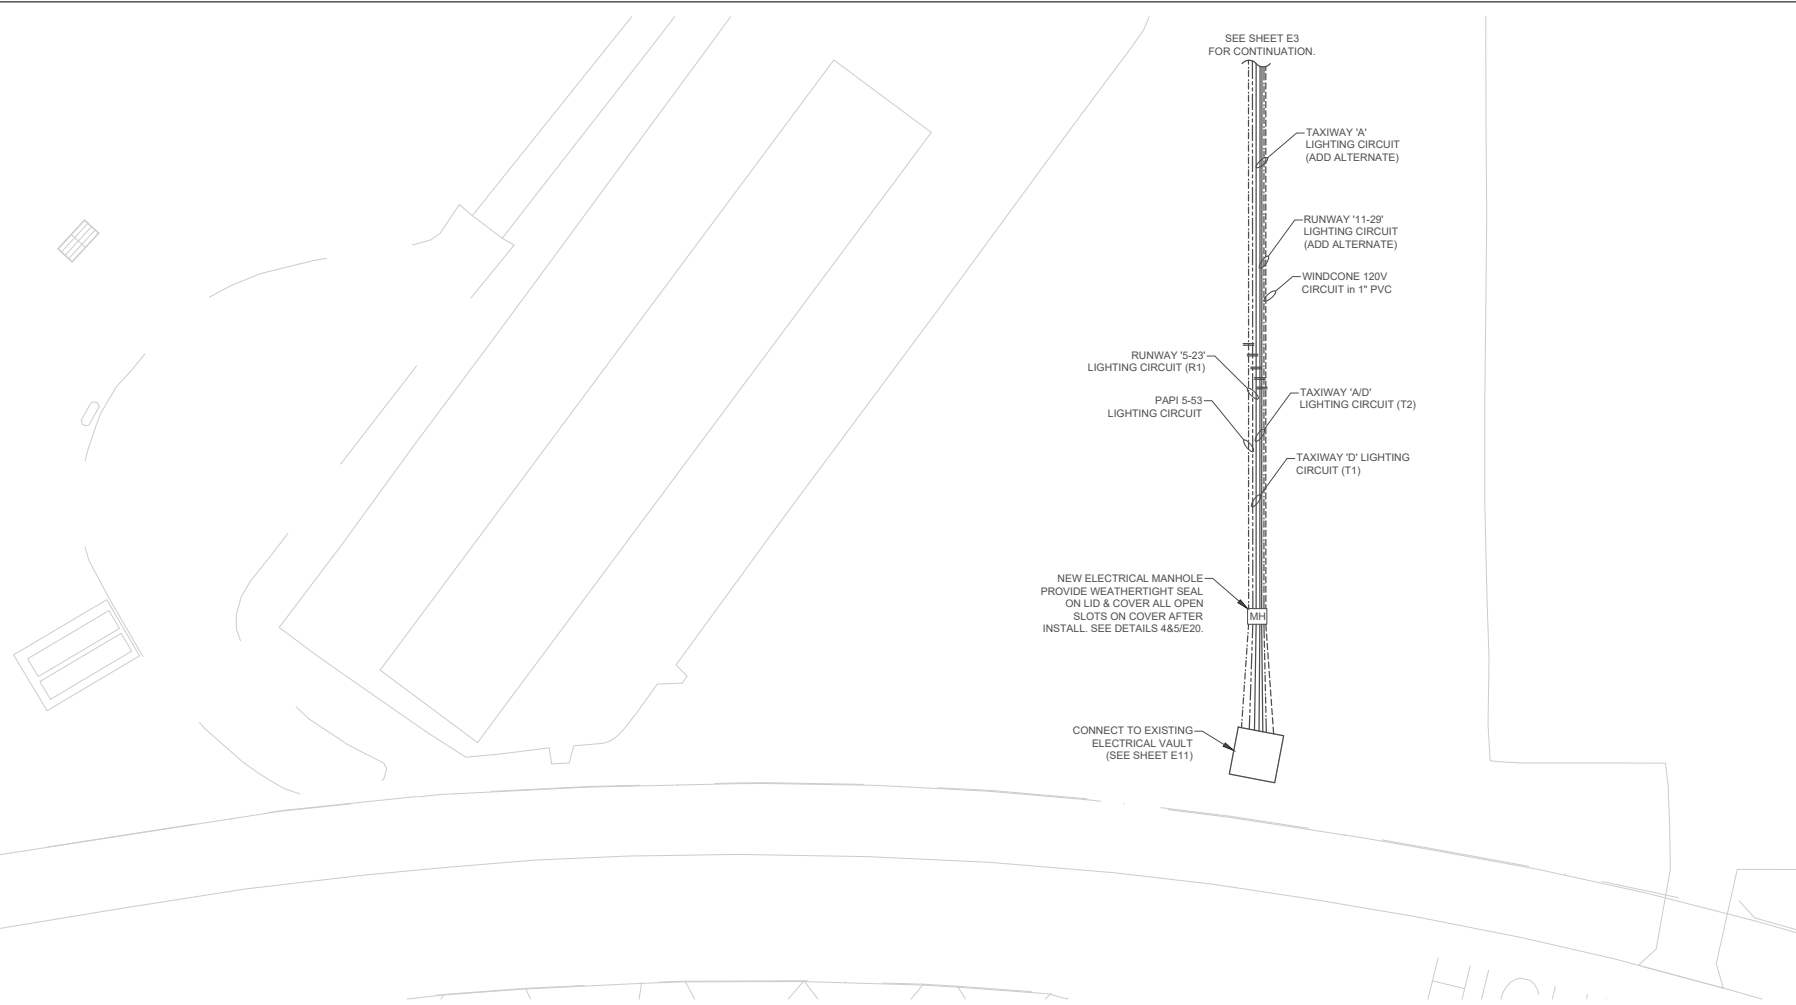

GENERAL NOTES:

1. ALL EXISTING UNDERGROUND CABLES, COUNTERPOISE, AND UTILITIES SHALL BE LOCATED PRIOR TO TRENCHING. EXISTING CABLES, COUNTERPOISE, AND UTILITIES THAT ARE EXISTING TO REMAIN AND ARE DAMAGED AS A RESULT OF THIS WORK SHALL BE REPAIRED AT THE CONTRACTOR'S EXPENSE.
2. EDGE LIGHTS SHALL BE INSTALLED AND LOCATED NO MORE THAN 10'-0" FROM THE EDGE OF PAVEMENT AND IN UNIFORM FASHION ALONG THE RUNWAY OR TAXIWAY.
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5. WHERE DUCT BANKS DO NOT TERMINATE INTO A HANDHOLE, INSTALL THE AIRFIELD WIRING CONDUITS INSIDE THE DUCT BANK CONDUITS.




AIRFIELD LIGHTING & WIRING PLAN - RUNWAY 5/23 - PART 7

SCALE: 1"=50'-0"

NOTE:

1. LOCATE ALL EXISTING UNDERGROUND UTILITIES, ELECTRICAL WIRING, IRRIGATION LINES, AND PIPING BEFORE DIGGING AND EXCAVATION FOR UNDERGROUND CONDUITS, BOXES, PAD EXCAVATION, GROUNDING, ETC. IN ADDITION, CONTACT LOCAL UTILITY COMPANY PROVIDER AND COORDINATE WITH OWNER 3-DAYS BEFORE DIGGING FOR MARKING THE UNDERGROUND UTILITIES. ANY EXISTING UTILITIES, PIPING, AND CABLES/CONDUITS SHOWN ON THESE PLANS ARE FOR GENERAL REFERENCE ONLY AND MAY NOT BE ACCURATE AS TO WHAT IS EXISTING ON SITE.

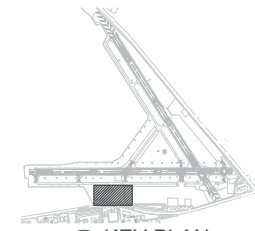

KEY PLAN
TRUE NORTH NOT TO SCALE

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TOOKS SUBMITTAL	1/20/2023
DESIGNED BY:	JDZ
DRAWN BY:	JRA, JDZ
CHECKED BY:	JEA

AIRFIELD LIGHTING & WIRING PLAN - RUNWAY 5/23 - PART 7

AIRFIELD ELECTRICAL UPGRADE DANIEL FIELD AIRPORT (DNL)

AUGUSTA, GEORGIA
AP019-XXX-XX(245)
GMC NUMBER : TAUG220004
SCALE: 1"=50'

E7
Sheet 31 of 52

ISSUE DATE	ISSUE
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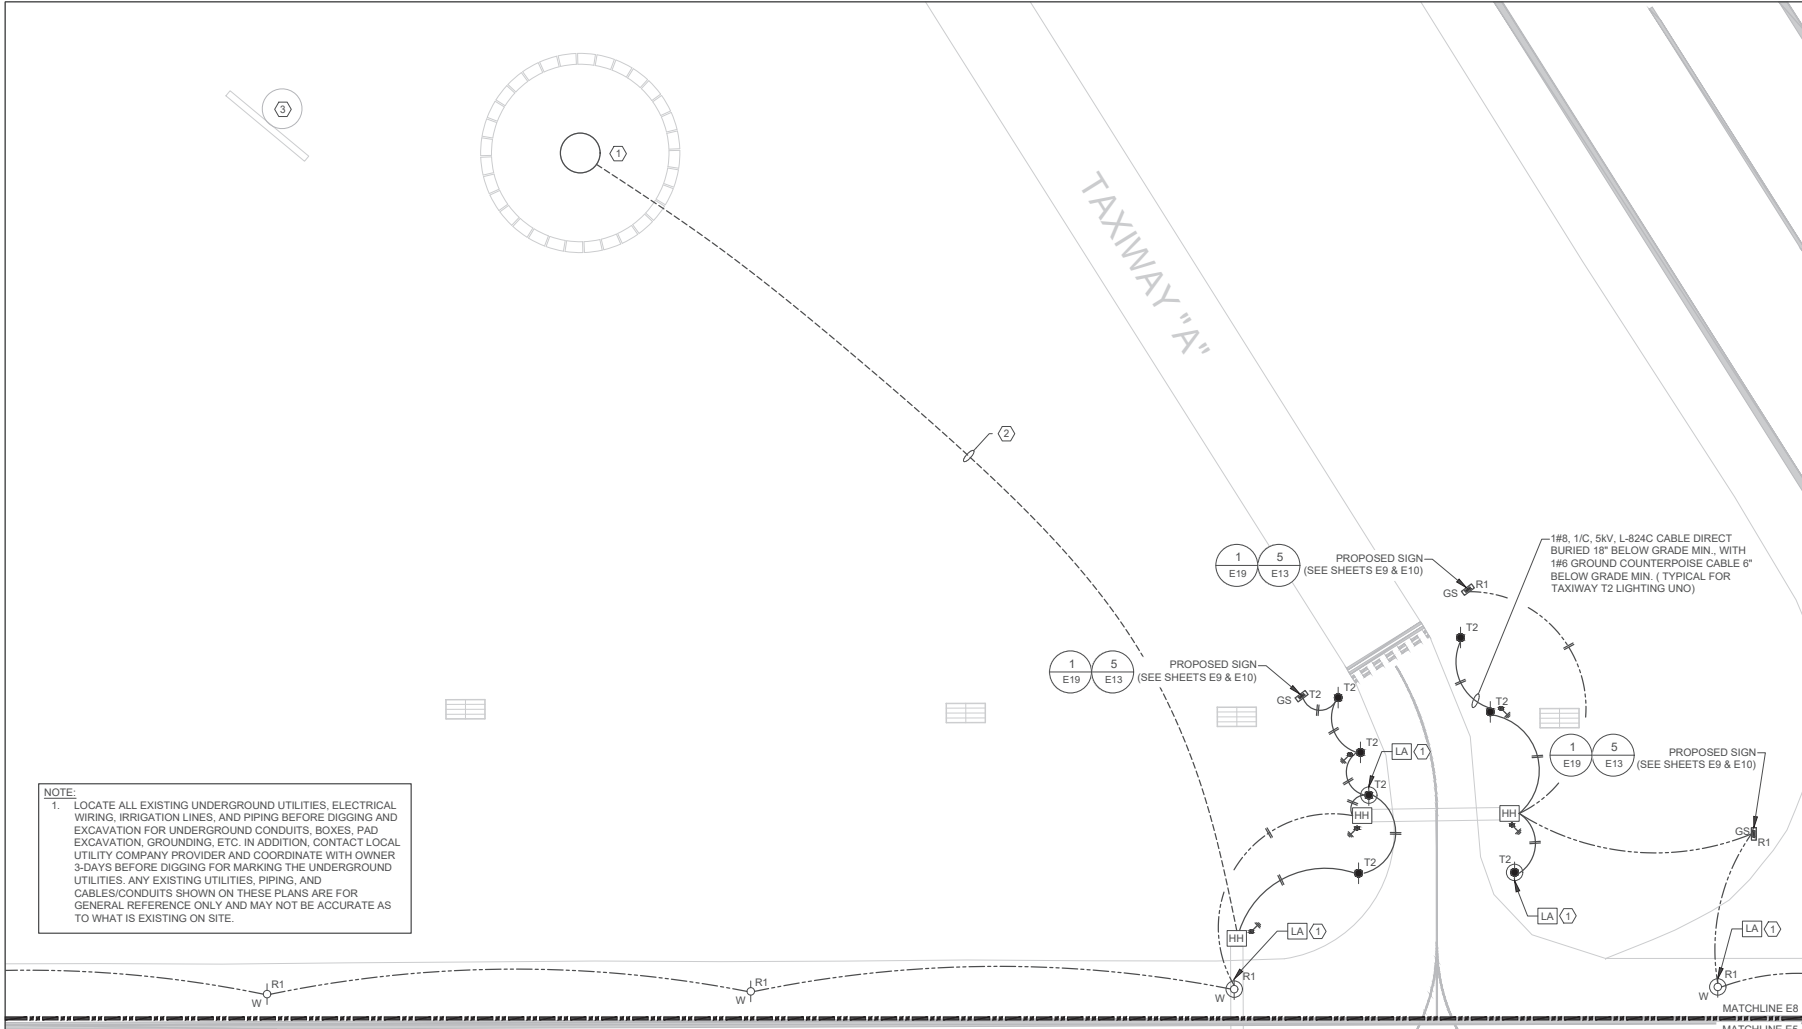
designed by: JDZ
 drawn by: JRA, JDZ
 checked by: JEA

**AIRFIELD ELECTRICAL UPGRADE
 DANIEL FIELD AIRPORT (DNL)**

AUGUSTA, GEORGIA
 AP019-XXX-XX(245)
 GMC NUMBER : TAUG220004
 SCALE: 1"=50'



**AIRFIELD LIGHTING
 & WIRING PLAN
 - EXISTING AWOS
 SYSTEM
 E8**




NOTE:
 1. LOCATE ALL EXISTING UNDERGROUND UTILITIES, ELECTRICAL WIRING, IRRIGATION LINES, AND PIPING BEFORE DIGGING AND EXCAVATION FOR UNDERGROUND CONDUITS, BOXES, PAD EXCAVATION, GROUNDING, ETC. IN ADDITION, CONTACT LOCAL UTILITY COMPANY PROVIDER AND COORDINATE WITH OWNER 3-DAYS BEFORE DIGGING FOR MARKING THE UNDERGROUND UTILITIES. ANY EXISTING UTILITIES, PIPING, AND CABLES/CONDUITS SHOWN ON THESE PLANS ARE FOR GENERAL REFERENCE ONLY AND MAY NOT BE ACCURATE AS TO WHAT IS EXISTING ON SITE.

- GENERAL NOTES:**
- ALL EXISTING UNDERGROUND CABLES, COUNTERPOISE, AND UTILITIES SHALL BE LOCATED PRIOR TO TRENCHING. EXISTING CABLES, COUNTERPOISE, AND UTILITIES THAT ARE EXISTING TO REMAIN AND ARE DAMAGED AS A RESULT OF THIS WORK SHALL BE REPAIRED AT THE CONTRACTOR'S EXPENSE.
 - EDGE LIGHTS SHALL BE INSTALLED AND LOCATED NO MORE THAN 10'-0" FROM THE EDGE OF PAVEMENT AND IN UNIFORM FASHION ALONG THE RUNWAY OR TAXIWAY.
 - PROVIDE HANDHOLE PULL JUNCTION BOXES WHERE INDICATED AS A MINIMUM. PROVIDE ADDITIONAL HANDHOLE PULL JUNCTION BOXES OF THE SAME SIZE AND TYPE WHERE NECESSARY SO AS NOT TO EXCEED THE CABLE/CONDUCTOR'S MAXIMUM ALLOWED PULLING TENSION AND NOT TO EXCEED THE EQUIVALENT OF 360 DEGREES IN BENDS BETWEEN ANY TWO CONDUIT TERMINATION POINTS.
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 - WHERE DUCT BANKS DO NOT TERMINATE INTO A HANDHOLE, INSTALL THE AIRFIELD WIRING CONDUITS INSIDE THE DUCT BANK CONDUITS.


AIRFIELD LIGHTING & WIRING PLAN - EXISTING AWOS SYSTEM & WINDCONE
 SCALE: 1"=50'-0"

- KEYED NOTES:**
- EXISTING 120V CIRCUIT TO WIND CONE TO BE REPLACED WITH NEW. MAKE NEW ELECTRICAL CONNECTION AS PER MANUFACTURER'S REQUIREMENTS. EXISTING WINDCONE IS A HALI-BRITE INC. #L807-S2-IN-120-ON-5. UTILIZE 4/0 WIRE IN 2" CONDUIT TO ACHIEVE <3% VOLTAGE DROP.
 - 2#/0, 1#/0(G) - 2" TO PANEL 'EVP' IN ELECTRICAL VAULT.
 - EXISTING AWOS SYSTEM TO REMAIN IN SERVICE - NO WORK REQUIRED.
 - PROVIDE FIELD LIGHTNING ARRESTOR FOR SERIES CIRCUIT AS SPECIFIED. LIGHTING ARRESTOR TO BE ADB #FL4446102 OR APPROVED EQUAL. INSTALL ARRESTOR IN THE BASE CAN INDICATED AND CONNECT TO THE SERIES LIGHTING CIRCUIT PER MANUFACTURER'S REQUIREMENTS. GROUND PER NEC AND FAA REGULATIONS. GROUND ARRESTOR TO BASE CAN GROUND LUG USING A #4 COPPER GROUND CONDUCTOR. PROVIDE A RED TAG WITH WHITE 'LA' LETTERS ON FIXTURE STEM. TAG SHALL MATCH DETAIL 3/E13 EXCEPT FOR THE COLOR.

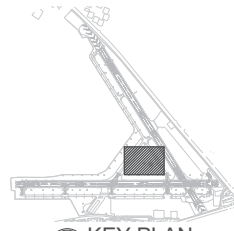

MATCHLINE E8
 MATCHLINE E5


SIGN CHART			
S1	5	S16	29-11
S2	D→	S17	11-29
S3	5-23	S18	TER
S4	← TERM	S19	D→
S5	← E	S20	23
S6	C→	S21	23-5
S7	5-23	S22	11-29
S8	← E	S23	← E
S9	← C	S24	TERM
S10	A→	S25	← E
S11	5-23		
S12	TER→		
S13	← TER		
S14	5-23		
S15	11-29		

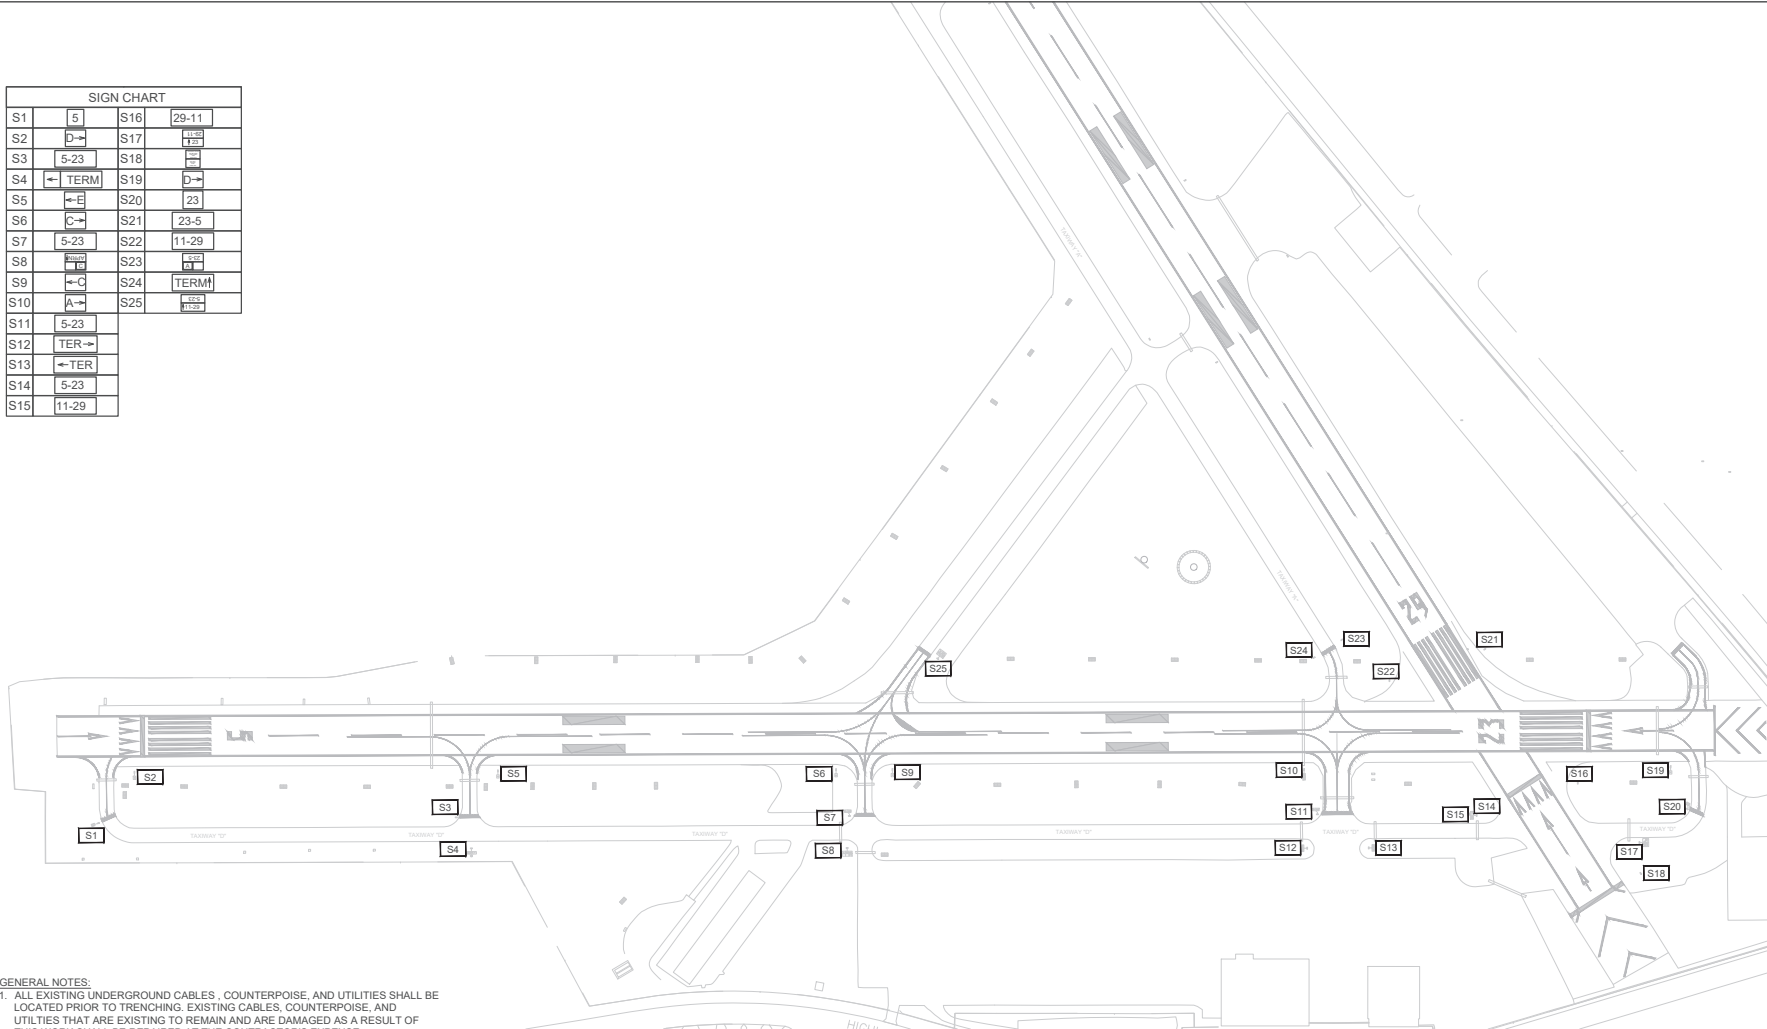

GENERAL NOTES:

1. ALL EXISTING UNDERGROUND CABLES, COUNTERPOISE, AND UTILITIES SHALL BE LOCATED PRIOR TO TRENCHING. EXISTING CABLES, COUNTERPOISE, AND UTILITIES THAT ARE EXISTING TO REMAIN AND ARE DAMAGED AS A RESULT OF THIS WORK SHALL BE REPAIRED AT THE CONTRACTOR'S EXPENSE.
2. ALL AIRPORT SIGNS SHALL CONFORM TO THE FOLLOWING FAA ADVISORY CIRCULARS:
150/5340-18F STANDARDS FOR AIRPORT SIGN SYSTEMS
150/5340-30J DESIGN AND INSTALLATION DETAILS FOR AIRPORT VISUAL AIDS
150/5345-44J SPECIFICATION FOR RUNWAY & TAXIWAY SIGNS.
3. ALL SIGNS SHALL BE SIZE 1, STYLE 2, CLASS 2, MODE 2, UNLESS DIRECTED OTHERWISE BY THE ENGINEER.
4. CONTRACTOR SHALL STAKE THE LOCATION OF ALL PROPOSED SIGNS FOR REVIEW BY THE RPR PRIOR TO INSTALLATION.
5. TYPICAL, SEE SHEET E10 FOR SIGN LAYOUTS.

PLAN NORTH  1 E9 AIRFIELD SIGN CHART PLAN - RUNWAY 5-23 SCALE: 1"=300'-0"

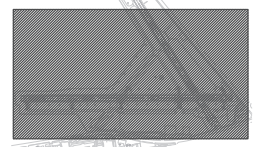

KEY PLAN
TRUE NORTH  NOT TO SCALE



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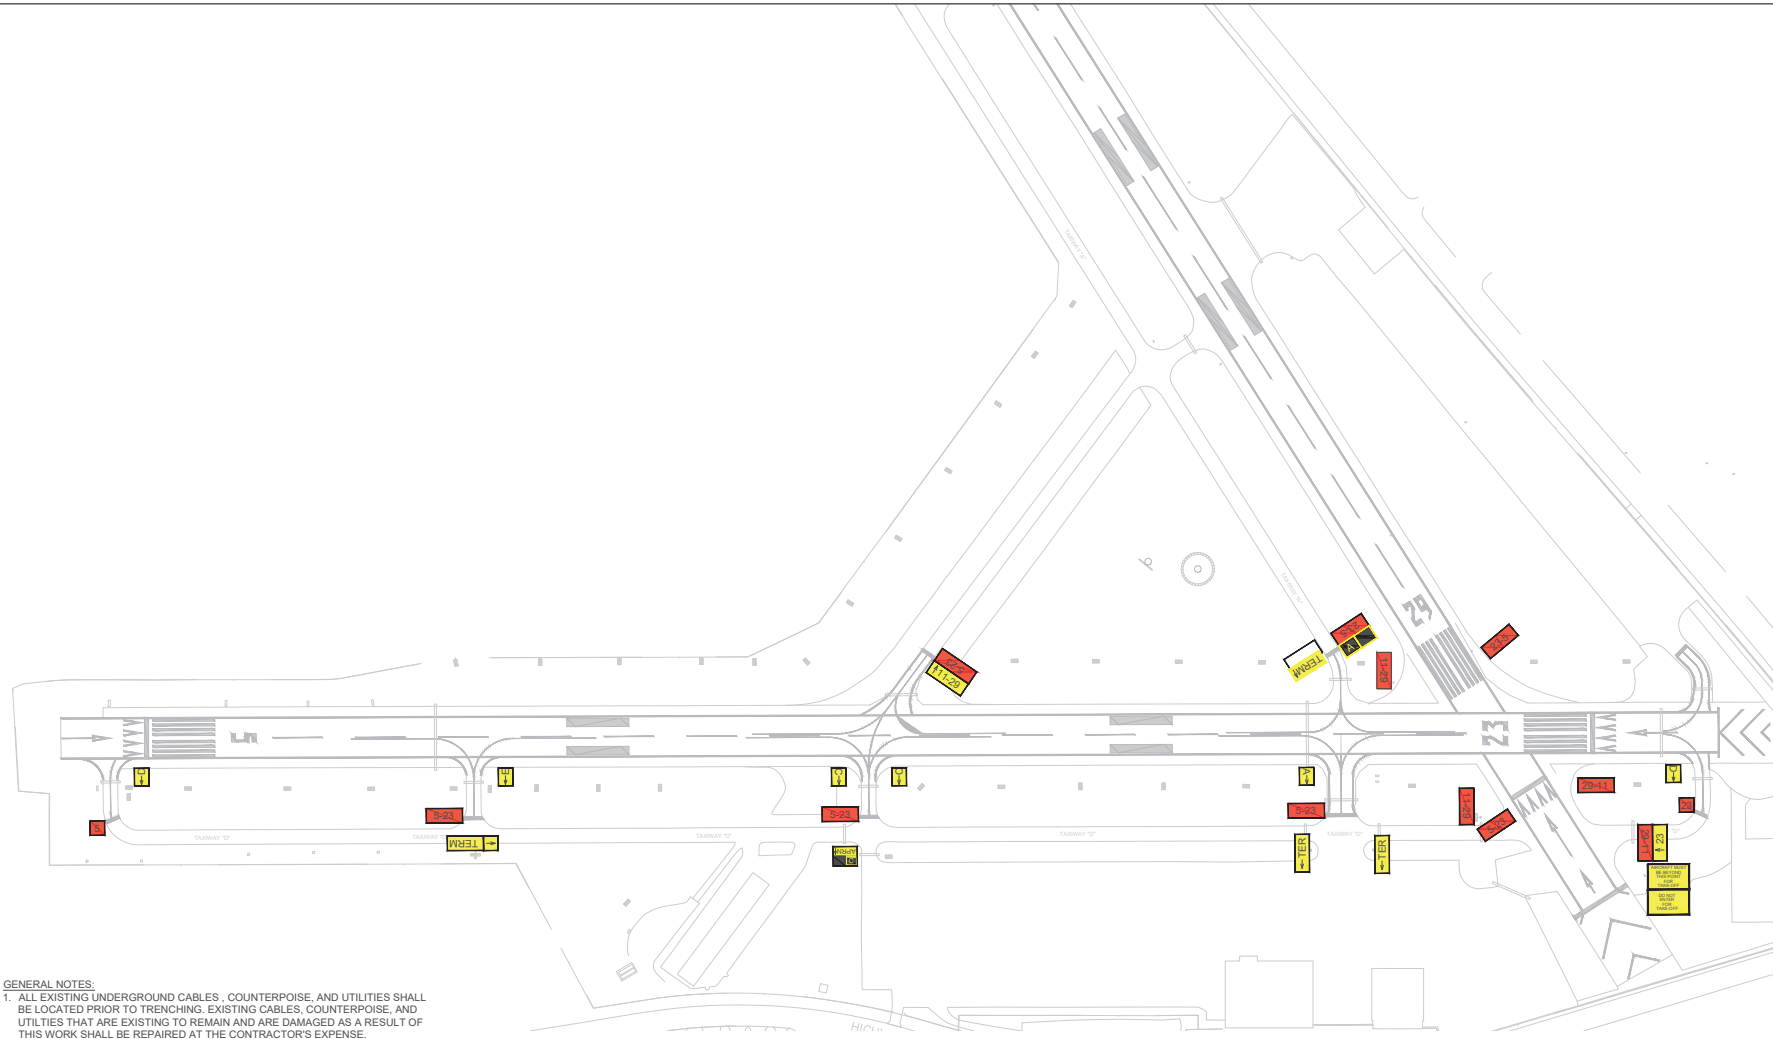
designed by: JDZ
drawn by: JRA, JDZ
checked by: JEA

AIRFIELD ELECTRICAL UPGRADE
DANIEL FIELD AIRPORT (DNL)
AUGUSTA, GEORGIA
AP019-XXX-XX(245)
GMC NUMBER : TAUG220004
SCALE: 1" = 300'



AIRFIELD SIGN CHART PLAN
- RUNWAY 5-23
E9
Sheet 33 of 52


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- GENERAL NOTES:**
1. ALL EXISTING UNDERGROUND CABLES, COUNTERPOISE, AND UTILITIES SHALL BE LOCATED PRIOR TO TRENCHING. EXISTING CABLES, COUNTERPOISE, AND UTILITIES THAT ARE EXISTING TO REMAIN AND ARE DAMAGED AS A RESULT OF THIS WORK SHALL BE REPAIRED AT THE CONTRACTOR'S EXPENSE.
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150/5340-30J DESIGN AND INSTALLATION DETAILS FOR AIRPORT VISUAL AIDS
150/5345-44J SPECIFICATION FOR RUNWAY & TAXIWAY SIGNS.
 3. ALL SIGNS SHALL BE SIZE 1, STYLE 2, CLASS 2, MODE 2, UNLESS DIRECTED OTHERWISE BY THE ENGINEER.
 4. CONTRACTOR SHALL STAKE THE LOCATION OF ALL PROPOSED SIGNS FOR REVIEW BY THE RPR PRIOR TO INSTALLATION.

PLAN NORTH 1 E10 SCALE: 1"=300'-0"

AIRFIELD SIGN LAYOUT PLAN RUNWAY 5-23



KEY PLAN
TRUE NORTH NOT TO SCALE

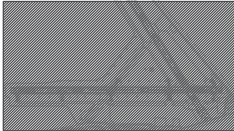VAUG220003




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ISSUE DATE	
100% SUBMITTAL	1/20/2023
DESIGNED BY:	JAZ
DRAWN BY:	JRA, JDZ
CHECKED BY:	JEA

**AIRFIELD ELECTRICAL UPGRADE
DANIEL FIELD AIRPORT (DNL)**
AUGUSTA, GEORGIA
AP019-XXX-XX(245)
GMC NUMBER : TAUG220004
SCALE: 1" = 300'




**AIRFIELD SIGN
LAYOUT PLAN
- RUNWAY 5-23**
E10
Sheet 34 of 52

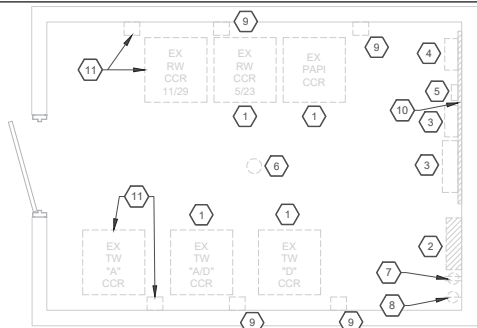


1 ELECTRICAL VAULT DEMOLITION PLAN
SCALE: 1/2"=1'-0"

- DEMOLITION KEYED NOTES**
- EXISTING REGULATOR TO BE REPLACED WITH NEW. DISCONNECT AND REMOVE REGULATOR WITH ALL ASSOCIATED COMPONENTS AND TURN IT OVER TO OWNER. CONTRACTOR TO REPLACE ALL UPSTREAM WIRING BACK TO PANEL 'EVP' WITH NEW. DISCONNECT FEEDER WIRING & CONDUIT AND TURN IT OVER TO OWNER. CONTRACTOR HAS OPTION TO REUSE EXISTING CONDUIT IF IT MEETS DESIGN INTENT AND IS CODE COMPLIANT WITH THE NEC.
 - EXISTING 240/120V 1PH 200AMP PANELBOARD TO BE REPLACED WITH NEW. SEE NEW PANEL SCHEDULE 'EVP'. COORDINATE WITH OWNER ON SCHEDULING DOWN TIME OF AIRFIELD LIGHTING SYSTEM DURING CONSTRUCTION.
 - EXISTING LIGHTING CONTROL JUNCTION BOX AND CONTROL BOX TO BE DEMOLISHED AND BE REPLACED WITH NEW.
 - EXISTING RADIO CONTROLLER TO BE REPLACED WITH NEW.
 - EXISTING TIMECLOCK TO BE DEMOLISHED AND BE REPLACED WITH NEW.
 - EXISTING LIGHT FIXTURE TO BE DEMOLISHED. REMOVE ALL ASSOCIATED WIRING, CONDUIT, SWITCHES, AND BOXES.
 - EXISTING RECEPTACLE TO BE DEMOLISHED. REMOVE ALL ASSOCIATED WIRING, CONDUIT, & BOXES.
 - EXISTING 30AMP 120V OUTLET TO REMAIN AND BE RECONNECTED TO NEW PANEL 'EVP'.
 - EXISTING ADB SAFETY CUTOUT TO BE DEMOLISHED. REMOVE ALL ASSOCIATED WIRING & CONDUIT.
 - EXISTING BACKBOARD FOR CONTROLS TO REMAIN.
 - IF 11/29 ALTERNATE IS NOT ACCEPTED, EXISTING REGULATOR & SAFETY CUTOUT TO REMAIN IN SERVICE. CONNECT NEW INCOMING POWER (WIRING & CONDUIT) TO NEW PANEL 'EVP' IN VAULT AS REQUIRED.

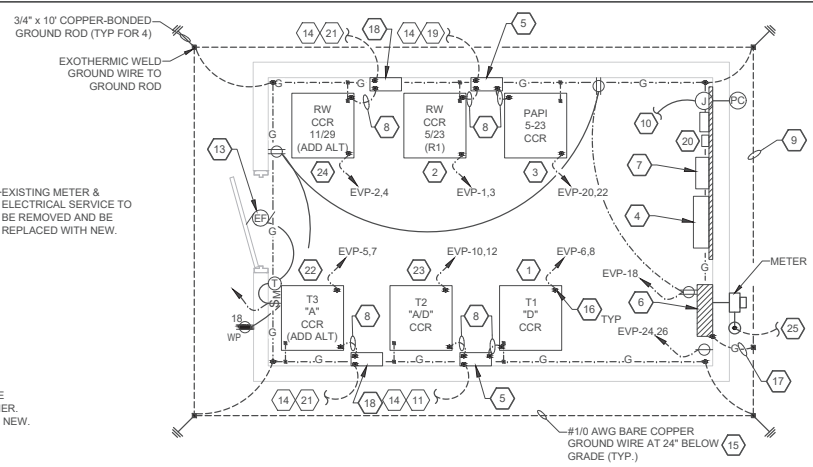

2 ELECTRICAL VAULT PLAN
SCALE: 1/2"=1'-0"

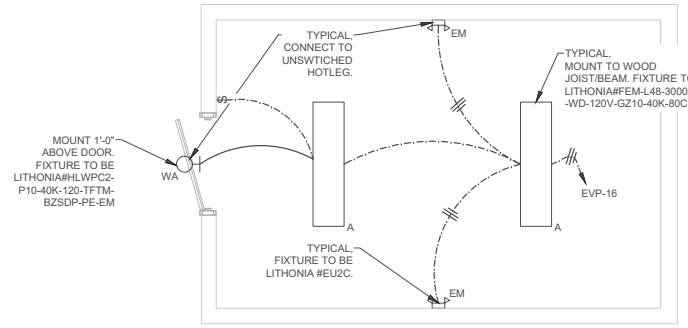

3 VAULT LIGHTING PLAN
SCALE: 1/2"=1'-0"

NOTE:
IF PRICE OR QUOTE FROM GEORGIA POWER IS NOT RECEIVED SUCCESSFULLY PRIOR TO THE BID, CONTRACTOR SHALL PROVIDE AN ALLOWANCE IN BASE BID OF \$15,000.00 TO COVER ANY ASSOCIATED UTILITY COSTS FOR NEW ELECTRICAL SERVICE TO THE VAULT BUILDING.

- KEYED NOTES**
- NEW 10KW 3-STEP REGULATOR FOR TAXIWAY T1 CIRCUIT. DIMENSIONS OF REGULATOR ARE BASED ON MANUFACTURER. CONTRACTOR SHALL ADJUST LAYOUT DUE TO REGULATORS OF DIFFERENT SIZES. ROUTE TO NEW L-821 CONTROL PANEL AS REQUIRED. THYRISTOR OR SCR CCR SHALL HAVE TAP SETTING OF 60%.
 - NEW 15KW 3-STEP REGULATOR FOR RUNWAY 5/23 (R1) CIRCUIT. DIMENSIONS OF REGULATOR ARE BASED ON MANUFACTURER. CONTRACTOR SHALL ADJUST LAYOUT DUE TO REGULATORS OF DIFFERENT SIZES. ROUTE TO NEW L-821 CONTROL PANEL AS REQUIRED. THYRISTOR OR SCR CCR SHALL HAVE TAP SETTING OF 60%.
 - NEW 4KW 3-STEP REGULATOR FOR PAPI 5-23 CIRCUIT. DIMENSIONS OF REGULATOR ARE BASED ON MANUFACTURER. CONTRACTOR SHALL ADJUST LAYOUT DUE TO REGULATORS OF DIFFERENT SIZES. THYRISTOR OR SCR CCR SHALL HAVE TAP SETTING OF 50%.
 - NEW L-821 LIGHTING RELAY CABINET. PROVIDE RELAYS AND SWITCHES AS REQUIRED FOR AIRPORT LIGHTING CONTROL SYSTEM AS INDICATED ON DETAIL 2/E12.
 - TYPICAL PROVIDE HINGED ENCLOSURE WITH TWO CUT-OUTS. EQUAL TO ADB ALCS OR APPROVED EQUAL.
 - NEW PANELBOARD 'EVP'. SEE PANEL SCHEDULE FOR DETAILS. CONTRACTOR TO PROVIDE ALL NEW BREAKERS AS SHOWN IN PANEL SCHEDULE 'EVP'. PANEL TO BE SQUARE D NOOD OR APPROVED EQUAL.
 - NEW L-854 RADIO CONTROLLER. VERIFY FINAL LOCATION AND CONTROLS WITH OWNER PRIOR TO INSTALL. PROVIDE RELAYS AND SWITCHES AS REQUIRED FOR AIRPORT LIGHTING CONTROL SYSTEM. SEE WIRING DIAGRAM 2/E12.
 - 2#8, 5KV, L-824C CABLES IN 2" FLEXIBLE METAL CONDUIT.
 - #10 AWG GROUND LOOP AROUND VAULT. BOND REGULATORS, CONTACTORS, AND RELAY ENCLOSURES TO GROUND WITH #4 AWG. EXTEND #10 AWG GROUND AND CONNECT TO NEW GROUND LOOP.
 - NEW PHOTOCELL. EXTEND 3#12, 1#12(G), 1" C AND CONNECT TO RELAY PANEL. SEE DETAILS 2/E12 & 2/E13.
 - PROVIDE 2#8, 5KV L-824C CABLES (TAXIWAY T1) AND 2#8, 5KV L-824C CABLES (TAXIWAY T2) IN 4-1/2" TO NEW MANHOLE. SEE PLAN SHEET E7 FOR LOCATION.
 - NOT USED.
 - WALL MOUNTED EXHAUST FAN TO MATCH EXISTING WITH AUTOMATIC SHUTTER - MOUNT AT EXISTING LOCATION ABOVE ENTRY DOOR.
 - EXTEND CONDUITS AND COUNTERPOISE CABLE TO NEW MANHOLE IN COMMON TRENCH. COUNTERPOISE CABLE FROM SEPARATE TRENCHES SHALL BE BONDED TOGETHER THROUGH AN EXOTHERMIC WELD WHERE TRENCHES MEET. A SINGLE COUNTERPOISE CABLE SHALL PROCEED FROM THERE. PROVIDE SEALING COMPOUND ON ALL CONDUITS BETWEEN MANHOLE AND CUT OUT ENCLOSURES.
 - CONTRACTOR TO LOCATE ALL UNDERGROUND UTILITIES PRIOR TO COMMENCEMENT OF TRENCHING. ANY DAMAGED EXISTING UTILITY LINES WILL BE REPAIR AT THE CONTRACTOR'S EXPENSE.
 - MAKE ELECTRICAL CONNECTION TO NEW REGULATOR AS PER MANUFACTURER'S REQUIREMENTS. CONTRACTOR IS TO BE SURE A ON SITE PRE-COMMISSIONING MEETING WITH THE MANUFACTURER TO ENSURE INSTALLATIONS OF ALL SYSTEMS ARE FULLY FUNCTIONAL AND MEET DESIGN INTENT SHOWN IS COMPLETED PRIOR TO COMMENCEMENT OF WORK.
 - EXTEND #2 AWG GROUND IN 1" FROM PANEL 'EVP' AND CONNECT TO NEW GROUND LOOP.
 - IF RUNWAY 11-29 IS ACCEPTED, PROVIDE HINGED ENCLOSURE WITH ONE CUT-OUT. EQUAL TO ADB ALCS OR APPROVED EQUAL.
 - PROVIDE 2#8, 5KV, L-824C CABLES (RUNWAY 5-23 (R1)) AND 2#8, 5KV, L-824C CABLES (PAPI 5-23) IN 4-1/2" TO NEW MANHOLE. SEE PLAN SHEET E7 FOR LOCATION.
 - NEW TIMECLOCK. CONNECT TO LIGHTING RELAY CABINET AS REQUIRED. COORDINATE WITH OWNER PRIOR TO INSTALL. SEE WIRING DIAGRAM 2/E12.
 - IF RUNWAY 11-29 ALTERNATE IS ACCEPTED, PROVIDE 2#8, 5KV L-824C CABLES (RUNWAY R1) AND 2#8, 5KV L-824C CABLES (TAXIWAY T3) IN 4-1/2" TO NEW MANHOLE. SEE PLAN SHEET E7 FOR LOCATION.

PANELBOARD EVP SCHEDULE

LOCATION ELECTRICAL VAULT		MAIN: 400A MCB				SERVICE ENTRANCE RATED				
VOLTAGE 120/240		SYSTEM: 1Ø 3 WIRE								
TRM	SURFACE	INTERRUPTING RATING: 22k AC								
CKT #	LOAD DESCRIPTION	BREAKER P	TRIP	PHASE (KW) A	PHASE (KW) B	BREAKER TRIP P	LOAD DESCRIPTION	CKT #		
1	RUNWAY 5/23 CCR (R1)	2	125	7.50	3.75	60	2	RUNWAY 11/29 CCR (ALT)	2	
3	TAXIWAY A CCR (ALT) (T3)	2	60	3.75	5.00	80	2	TAXIWAY D CCR (T1)	6	
7	WIND CONE	1	20	0.10	3.75	5.00	20	1	VAULT FAN	12
11	LIGHTING CONTROL CAB	1	20	0.10	0.20	2.00	30	2	TAXIWAY A/D CCR (T2)	10
13	GATE	1	20	1.50	0.50	0.50	20	1	VAULT LIGHTING	14
15	RADIO CONTROLLER	1	20	0.50	0.50	20	1	VAULT RECEPTACLES	16	
17	SPARE	1	20	1.00	1.00	20	1	VAULT RECEPTACLES	18	
19	SPARE	1	20			2.00	30	2	PAPI 5-23	20
21	SPARE	1	20			2.00	30	2	PAPI 5-23	22
23	SPARE	1	20			2.20	30	2	RV OUTLET	24
25	AVAILABLE BUSSED SPACE				2.20				AVAILABLE BUSSED SPACE	26
27	AVAILABLE BUSSED SPACE								AVAILABLE BUSSED SPACE	28
29	AVAILABLE BUSSED SPACE								AVAILABLE BUSSED SPACE	30
31	AVAILABLE BUSSED SPACE								AVAILABLE BUSSED SPACE	32
33	AVAILABLE BUSSED SPACE								AVAILABLE BUSSED SPACE	34
35	AVAILABLE BUSSED SPACE								AVAILABLE BUSSED SPACE	36
37	AVAILABLE BUSSED SPACE								AVAILABLE BUSSED SPACE	38
39	SPD	2	30	0.10	0.10				AVAILABLE BUSSED SPACE	40
41									AVAILABLE BUSSED SPACE	42

NOTES:
BOLD * TEXT INDICATES EXISTING LOAD TO BE RECONNECTED TO NEW PANEL.

12.9	12.0	16.5	15.5
TOTAL (KVA) ØA	29.3	ØB	27.4
TOTAL CONNECTED LOAD (KVA)	56.7	TOTAL LOAD (AMPS)	236.3

PANELBOARD NOTES:
1. PROVIDE A BUS MOUNTED SPD, SQUARE D, EATON, OR APPROVED EQUAL. MATCH MANUFACTURER OF SUPPLIED PANEL.

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TOOKS, SUBMITTAL	1/20/2023
DESIGNED BY:	J.D.Z.
DRAWN BY:	J.R.A., J.D.Z.
CHECKED BY:	J.E.A.

AIRFIELD ELECTRICAL UPGRADE
DANIEL FIELD AIRPORT (DNL)

AUGUSTA, GEORGIA
APD19-XXX-XX(245)
GMC NUMBER : TAUG220004
SCALE: NOT TO SCALE

ELECTRICAL VAULT PLAN


E11
Sheet 35 of 52

VAUG220003


AIRPORT LIGHTING CONTROL SYSTEM NOTES:

- BETWEEN DUSK TO DAWN, THE NEW PHOTOCELL LOCATED IN THE NEW VAULT BUILDING SHALL AUTOMATICALLY SET THE RUNWAY 5/23 PAPI TO ITS LOW SETTING.
- BETWEEN DAWN TO DUSK, THE NEW PHOTOCELL LOCATED IN THE NEW VAULT BUILDING SHALL AUTOMATICALLY SET THE RUNWAY 5/23 PAPI TO ITS HIGH SETTING.
- THE NEW RADIO CONTROL UNIT LOCATED IN THE VAULT BUILDING SHALL OVERRIDE ALL RUNWAY, TAXIWAY AND PAPI SETTINGS IN "AUTOMATIC" MODE AND SHALL:
 - AT 3 PULSES: 1) TURN THE TAXIWAY REGULATOR ON AT 30%.
2) TURN THE PAPI REGULATOR ON.
3) TURN THE RUNWAY REGULATOR ON AT 10%.
 - AT 5 PULSES: 1) LEAVE THE TAXIWAY REGULATOR AT 30%.
2) LEAVE THE PAPI REGULATOR ON.
3) TURN THE RUNWAY REGULATOR ON AT 30%.
 - AT 7 PULSES: 1) LEAVE THE TAXIWAY REGULATOR ON AT 30%.
2) LEAVE THE PAPI REGULATOR ON.
3) TURN THE RUNWAY REGULATOR ON AT 100%.
- THE NEW L-821 LIGHTING CONTROL PANEL SHALL PROVIDE MANUAL CONTROL OF THE RUNWAY, TAXIWAY AND PAPI REGULATORS.
- THE CONTROL CONTRACTOR SHALL PROVIDE AND SUBMIT FOR APPROVAL THE TERMINATION OF DETAILS OF THE L-821 CONTROL PANEL, AND REGULATORS TO MATCH DESCRIBED CONTROL SCHEME.

CONTROL PANEL NAMEPLATE ON PHENOLIC TYPE LABEL. BLACK LETTERS ON WHITE BACKGROUND

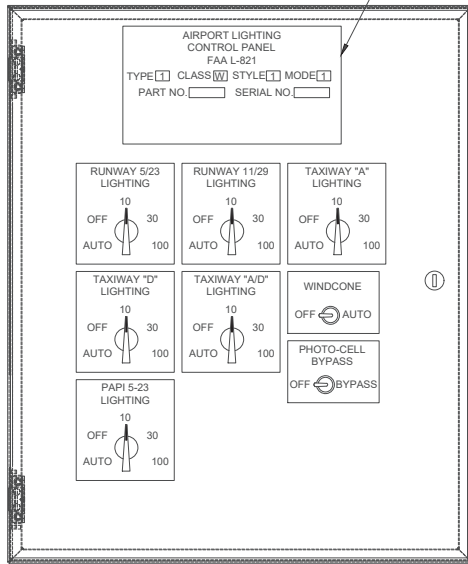

1 CONTROL PANEL L-821
E12 NOT TO SCALE

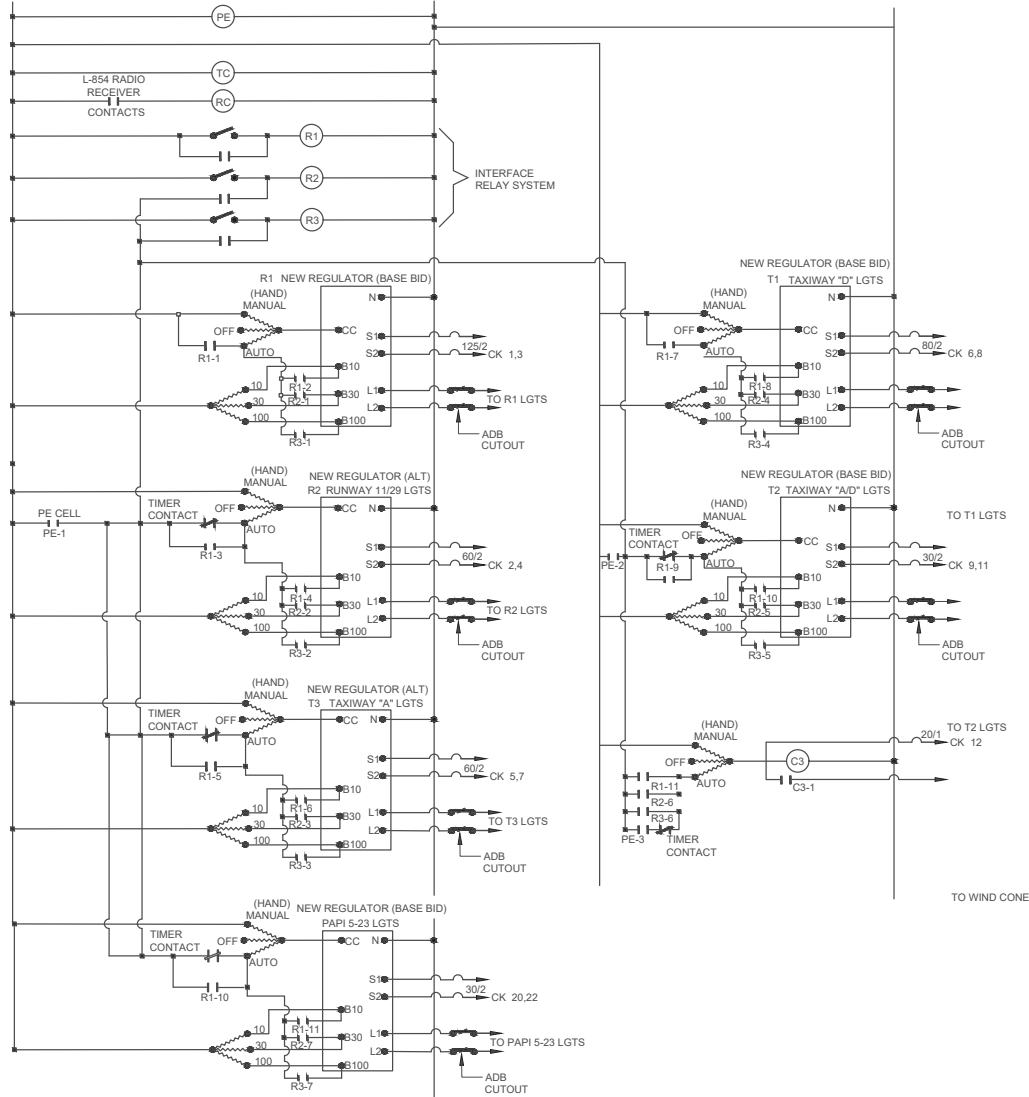

2 WIRING DIAGRAM
E12 NOT TO SCALE




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designed by:	J.D.Z.
drawn by:	J.R.A., J.D.Z.
checked by:	J.E.A.


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DANIEL FIELD AIRPORT (DNL)**
AUGUSTA, GEORGIA
AP019-XXX-XX(245)
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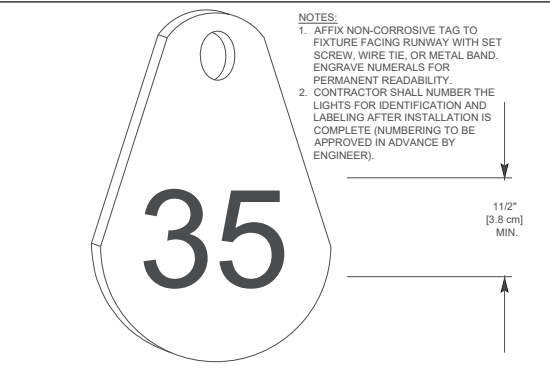
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Sheet 36 of 52





1
E13
2-WAY UNDERGROUND ELECTRICAL DUCT & CONCRETE DUCT MARKER SLAB
NOT TO SCALE

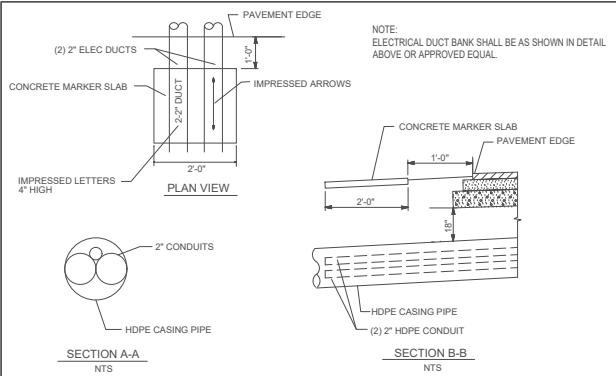


2
E13
INSTALLATION OF PHOTO CELL
DIAGRAMMATIC

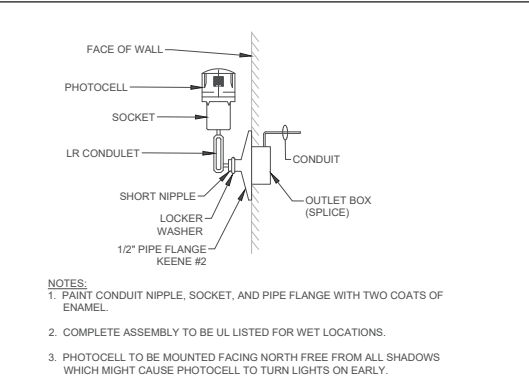

3
E13
TYPICAL LIGHT TAG DETAIL
NOT TO SCALE

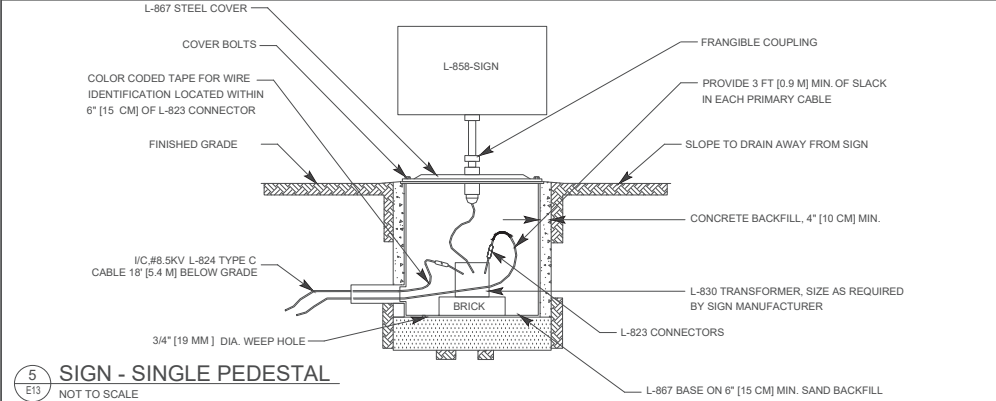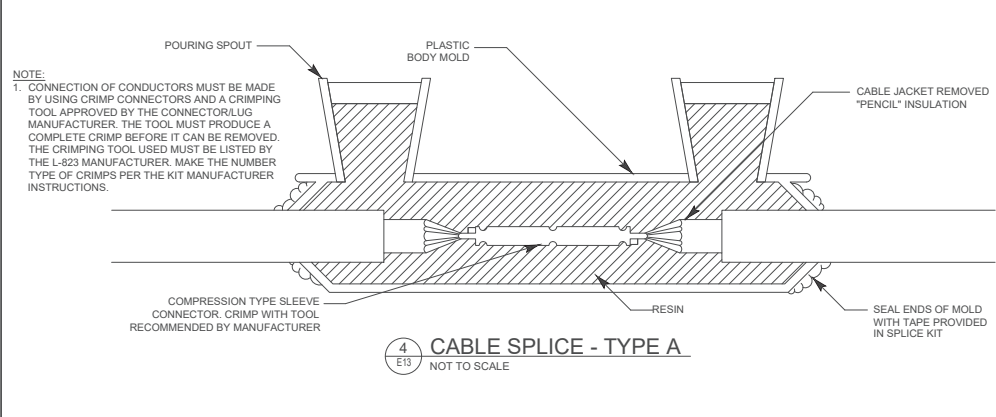

5
E13
SIGN - SINGLE PEDESTAL
NOT TO SCALE

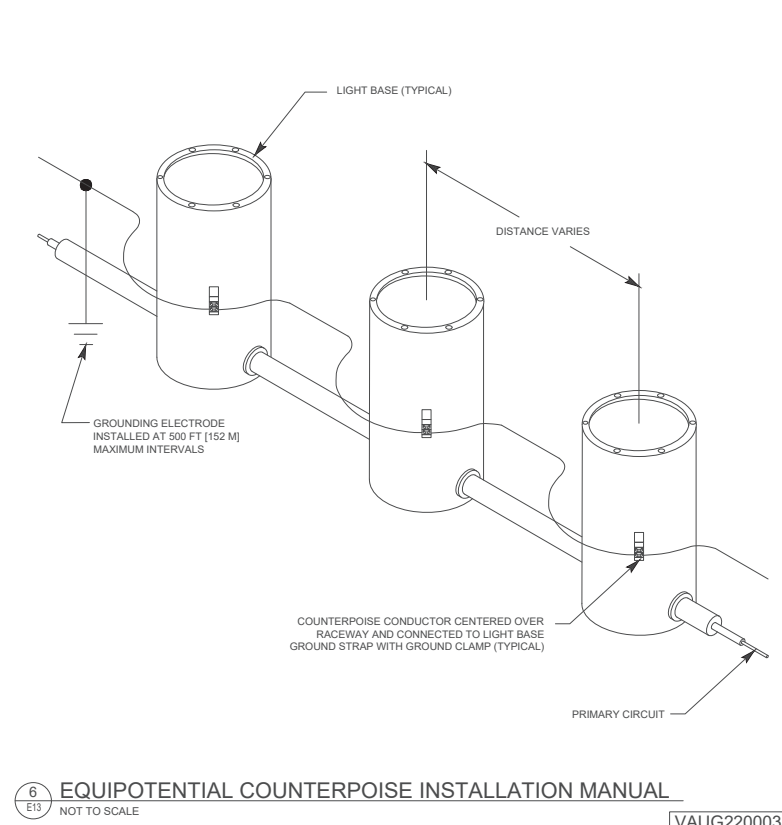

6
E13
EQUIPOTENTIAL COUNTERPOISE INSTALLATION MANUAL
NOT TO SCALE

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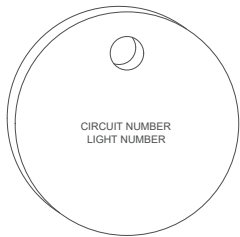
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DANIEL FIELD AIRPORT (DNL)**

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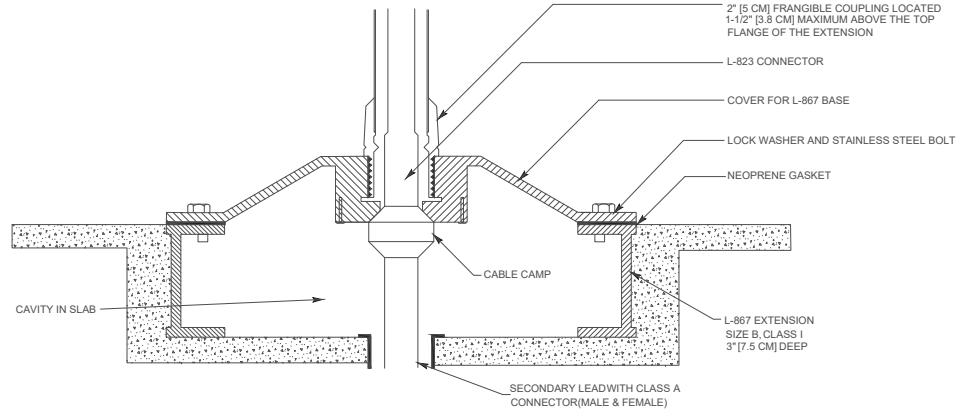
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Sheet 37 of 62

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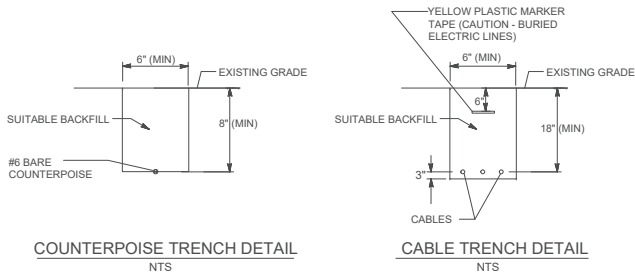
NOTES:

1. ALL CABLE ENTERING OR LEAVING A JUNCTION BOX SHALL BE IDENTIFIED WITH AN INDIVIDUAL IDENTIFICATION TAG INDICATING EACH LIGHTING OR POWER CIRCUIT. WHERE A SPLICE IS IN THE BOX, IDENTIFY THE CABLE ON BOTH SIDES OF THE SPLICE.
2. PAYMENT FOR CABLE AND FIXTURE TAGS AND CABLE SPLICES SHALL BE INCLUDED IN THE PRICE OF THE PARTICULAR FIXTURE, JUNCTION BOX OR CABLE RUN AND NO SEPARATE PAY ITEM INCLUDED FOR THESE ITEMS.
3. AN IDENTIFYING NUMBER SHALL BE ASSIGNED TO EACH LIGHT FIXTURE IN ACCORDANCE WITH THE DRAWINGS. THE PLACING OF THESE NUMBERS SHALL BE ACCOMPLISHED BY USE OF 1-1/2" DIAMETER NON-FERROUS METAL TAGS, WITH THE NUMBER APPROXIMATELY 1/4" IN HEIGHT, STAMPED IN, AND FASTENED TO THE CONDUIT RISER WITH A 3/32" STAINLESS STEEL AIRCRAFT CABLE AND GRIPPLE TO THE FIXTURE SO EACH FACES THE RUNWAY.




1 SERIES CABLE TAG DETAIL
E14 NOT TO SCALE

2 TYPICAL DETAIL FOR TAXIWAY HOLD & GUIDANCE SIGN
E14 NOT TO SCALE




COUNTERPOISE TRENCH DETAIL
NTS

CABLE TRENCH DETAIL
NTS

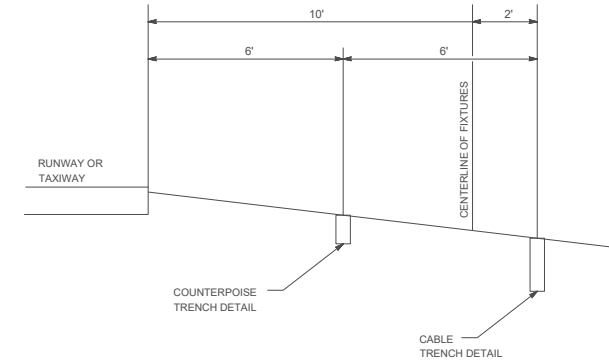

3 CABLE TRENCH DETAIL
E14 NOT TO SCALE

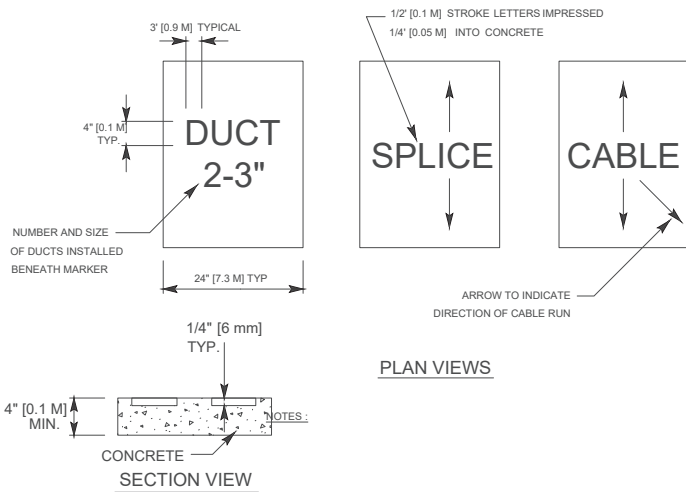

PLAN VIEWS

SECTION VIEW

1. PLACE MARKERS WHERE SHOWN ON PLANS AS DISCUSSED IN APPENDIX E, PARAGRAPH E.1, ELECTRICAL NOTES.
2. COST OF CONCRETE MARKERS IS INCIDENTAL TO THE ASSOCIATED ITEMS OF DUCT OR CABLE.
3. EDGE EXPOSED CONCRETE WITH A 1/4" [6 mm] RADIUS TOOL.
4. EMPLOY THE FOLLOWING METHODS WHERE ADDITIONAL SPACE TO FIT THE LEGEND IS REQUIRED:
 - A. REDUCE LETTER SIZE TO 3" HIGH, 2" WIDE [76 mm HIGH, 51 mm WIDE]
 - B. INCREASE THE MARKER SIZE TO 30" X 30" [0.9 M X 0.9 M] MAX.
 - C. PROVIDE ADDITIONAL MARKERS PLACED SIDE BY SIDE.


4 CABLE AND DUCT MARKER DETAIL
E14 NOT TO SCALE



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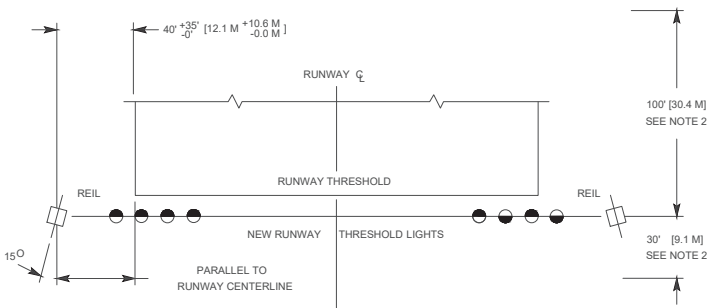
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DRAWN BY:	JRA, JDZ
CHECKED BY:	JEA

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ELECTRICAL DETAILS

E14
Sheet 38 of 52

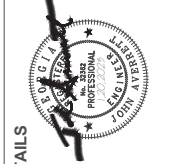


NOTES

1. THE OPTIMUM LOCATION FOR EACH LIGHT UNIT IS IN LINE WITH THE RUNWAY THRESHOLD LIGHTS 40 FT [12.1 M] Laterally FROM THE RUNWAY EDGE.
2. A 100 FT [30.4 M] UPWIND AND A 30 FT [9.1 M] DOWNWIND LONGITUDINAL TOLERANCE IS PERMITTED FROM THE RUNWAY THRESHOLD LIGHTS IN LOCATING THE LIGHT UNITS.
3. SPACE THE LIGHT UNITS EQUALLY FROM THE RUNWAY CENTERLINE. WHEN ADJUSTMENTS ARE NECESSARY THE DIFFERENCE IN THE DISTANCE OF THE UNITS FROM THE RUNWAY CENTERLINE MUST NOT EXCEED 10 FT [3 M].
4. THE BEAM CENTERLINE (AIMING ANGLE) OF EACH LIGHT UNIT IS AIMED 15 DEGREES OUTWARD FROM A LINE PARALLEL TO THE RUNWAY CENTERLINE AND INCLINED AT AN ANGLE 10 DEGREES ABOVE THE HORIZONTAL. IF ANGLE ADJUSTMENTS ARE NECESSARY, PROVIDE AN OPTICAL BAFFLE AND CHANGE THE ANGLE TO 10 DEGREES HORIZONTAL AND 20 DEGREES VERTICAL.
5. LOCATE THE REIL EQUIPMENT A MINIMUM DISTANCE OF 40 FT [12.1 M] FROM OTHER RUNWAYS AND TAXIWAYS.
6. IF REILS ARE USED WITH VASI, INSTALL REILS 75 FT [22.8 M] FROM THE RUNWAY EDGE. WHEN INSTALLED WITH OTHER GLIDE SLOPES INDICATORS, INSTALL REILS 40 FT [12.1 M] FROM THE RUNWAY EDGE IF THERE ARE CONCERNS WITH JET BLAST AND WIND VORTICES. SEE FAA ORDER JO 6850.2 FOR ADDITIONAL INFORMATION.
7. BOTH REIL UNITS MUST BE AT THE SAME ELEVATION AND WITHIN 3 FT [0.9 M] OF THE HORIZONTAL PLANE THROUGH THE RUNWAY CENTERLINE.

SYMBOL

- STEADY BURNING LIGHT, RED
- STEADY BURNING LIGHT, GREEN

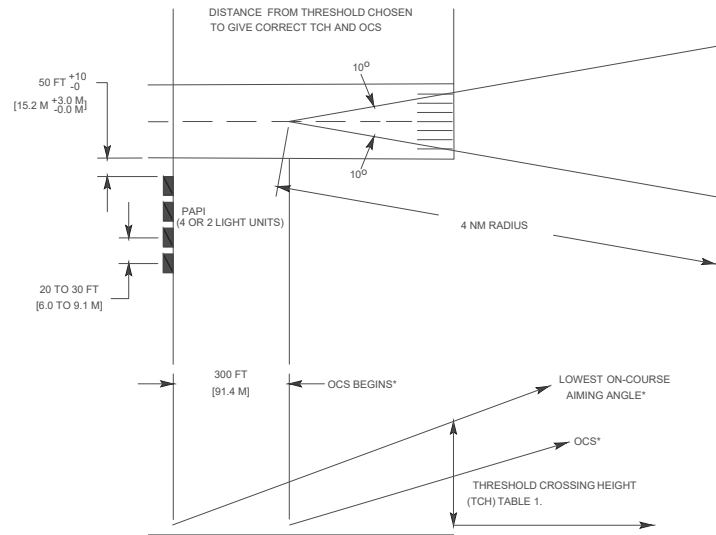

PAPI OCS ANGLE = LOWEST ON-COURSE AIMING ANGLE - 1 DEGREE

NOTES:

1. THE VISUAL GLIDE PATH ANGLE IS THE CENTER OF THE ON-COURSE ZONE, AND IS A NORMAL 3 DEGREES WHEN MEASURED FROM THE HORIZONTAL SURFACE OF THE RUNWAY.
 - A. FOR NON-JET RUNWAYS, THE GLIDE PATH MAY BE RAISED TO 4 DEGREES MAXIMUM TO PROVIDE OBSTACLE CLEARANCE.
 - B. IF THE PAPI GLIDE PATH IS CHANGED TO A HIGHER ANGLE FROM THE NOMINAL 3 DEGREES, IT MUST BE COMMUNICATED IN A NOTICE TO AIRMAN (NOTAM) AND PUBLISHED IN THE AIRPORT FACILITY DIRECTORY.
2. PAPI OCS.
 - A. THE PAPI OCS PROVIDES THE PILOT WITH A MINIMUM APPROACH CLEARANCE.
 - B. THE PAPI MUST BE POSITIONED AND AIMED SO NO OBSTACLES PENETRATE ITS SURFACE.
 - (1) THE OCS BEGINS 300 FEET [90 M] IN FRONT OF THE PAPI SYSTEM.
 - (2) THE OCS IS PROJECTED INTO THE APPROACH ZONE ONE DEGREE LESS THAN AIMING ANGLE OF THE THIRD LIGHT UNIT FROM THE RUNWAY FOR AN L-880 SYSTEM, OR THE OUTSIDE LIGHT UNIT FOR AN L-881 SYSTEM.

1 TYPICAL LAYOUT FOR REIL INSTALLATION
E15 NOT TO SCALE

2 PAPI OBSTACLE CLEARANCE SURFACE
E15 NOT TO SCALE

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checked by:	JEA

ELECTRICAL DETAILS
AIRFIELD ELECTRICAL UPGRADE
DANIEL FIELD AIRPORT (DNL)

AUGUSTA, GEORGIA


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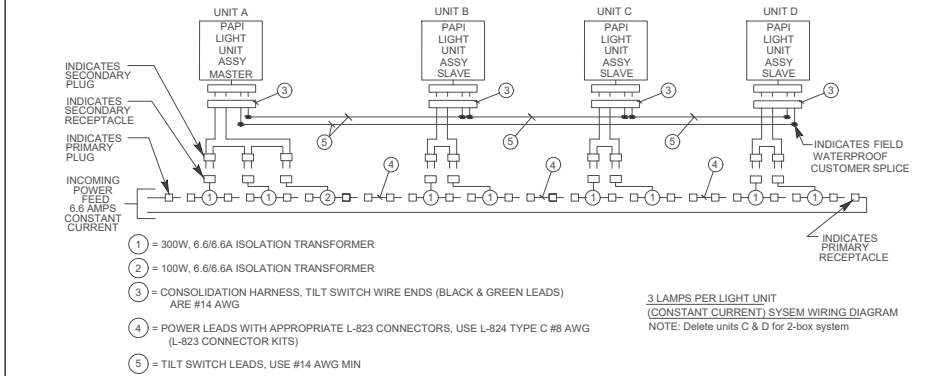
E15
Sheet 39 of 62



GENERAL NOTES:
(APPLICABLE TO THIS RISER ONLY)
A. REIL SHALL BE AN L-849(L), STYLE E (CURRENT-DRIVEN, UNIDIRECTIONAL 3-STEP) REIL.
B. THIS DETAIL IS BASED ON A TYPICAL L-849(L), STYLE E REIL. INSTALLATION REQUIREMENTS MAY VARY BETWEEN MANUFACTURERS. FINAL DETAIL SHALL BE APPROVED BY ENGINEER.
C. PROVIDE 3' OF SLACK IN EACH PRIMARY CABLE AND 2' FOR GROUNDING CONDUCTORS.
D. TAG ALL THRU CABLES ON BOTH SIDES OF SPLICE.

1 UNIDIRECTIONAL REIL SYSTEM DETAIL
E16 NOT TO SCALE

KEYED NOTES:
(APPLICABLE TO THIS RISER ONLY)
1. THE TOP ELEVATION OF BOTH FLASHHEADS SHALL BE WITHIN 3' OF A HORIZONTAL PLANE THROUGH THE RUNWAY CENTERLINE, WITH THE MAXIMUM HEIGHT LIMITED TO 3' ABOVE FINISHED GRADE AT THE FLASHHEAD.
2. BREAKING POINT ON FRANGIBLE COUPLING SHALL NOT BE HIGHER THAN 3' ABOVE FINISHED GRADE.

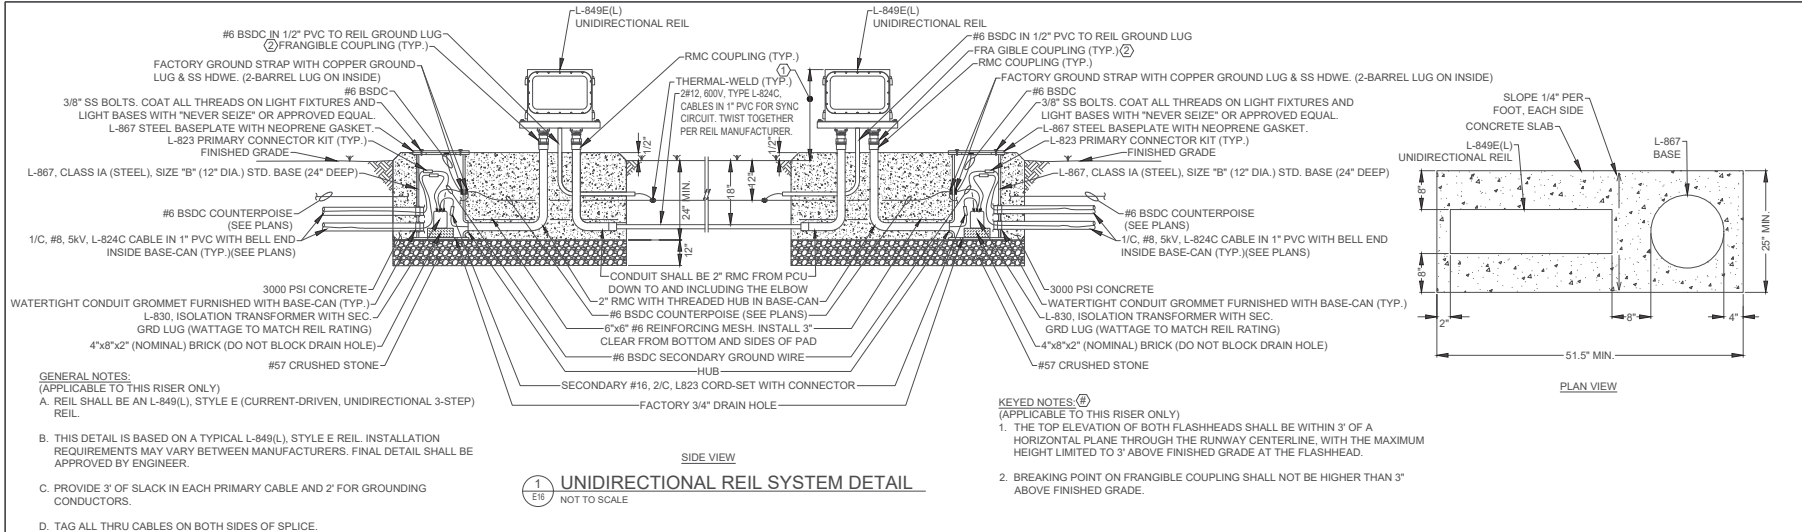

2 FAA L-880 STYLE "B" SYSTEM(WITH TILT SWITCHES)
E16 NOT TO SCALE

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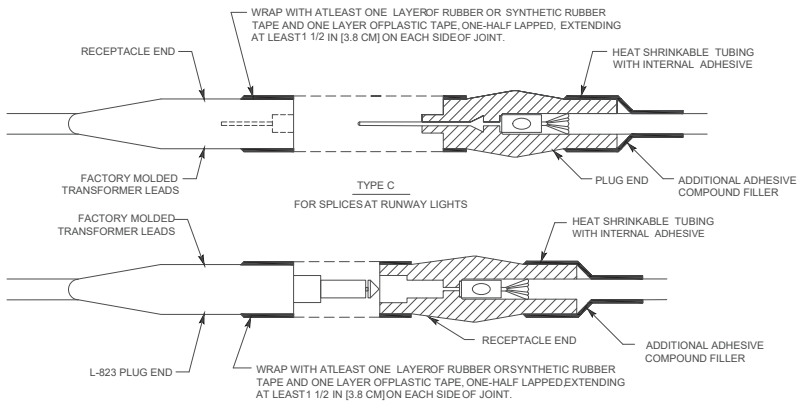
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DANIEL FIELD AIRPORT (DNL)
AUGUSTA, GEORGIA
AP019-XXX-XX(245)
GMC NUMBER : TAUG220004
SCALE: NOT TO SCALE




ELECTRICAL DETAILS

E16
Sheet 40 of 62




- NOTES:
1. SEE LIGHTING LAYOUT SHEET(S) FOR SPLICE TYPE
 2. PROPERLY MATCH THE INSIDE DIAMETER OF CONNECTOR TO THE OUTSIDE DIAMETER OF CABLE.
 3. CONNECTION OF CONDUCTORS MUST BE MADE BY USING CRIMP CONNECTORS AND A CRIMPING TOOL APPROVED BY THE CONNECTOR/LUG MANUFACTURER. THE TOOL MUST PRODUCE A COMPLETE CRIMP BEFORE IT CAN BE REMOVED. THE CRIMPING TOOL USED MUST BE LISTED BY THE L-823 KIT MANUFACTURER. MAKE THE NUMBER AND TYPE OF CRIMPS PER THE KIT MANUFACTURER'S INSTRUCTIONS.

1
E17
CABLE SPLICES
NOT TO SCALE

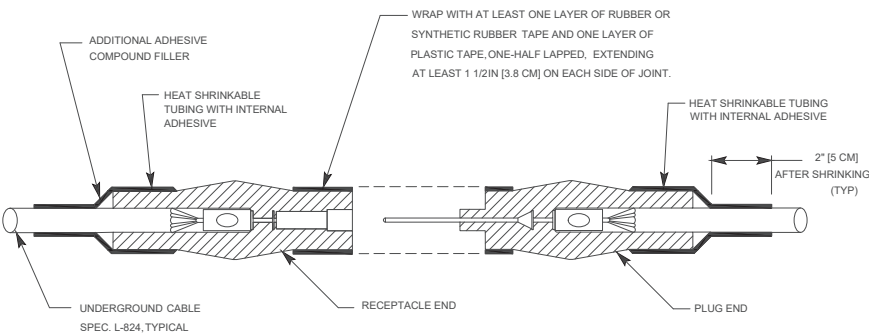


NOTE: FOR SPLICES FOR USE AT JUNCTION OF CONNECTION OF CONDUCTORS MUST BE MADE BY USING CRIMP CONNECTORS AND A CRIMPING TOOL APPROVED BY THE CONNECTOR/LUG MANUFACTURER. THE TOOL MUST PRODUCE A COMPLETE CRIMP BEFORE IT CAN BE REMOVED. THE CRIMPING TOOL USED MUST BE LISTED BY THE L-823 KIT MANUFACTURER. MAKE THE NUMBER AND TYPE OF CRIMPS PER THE KIT MANUFACTURER'S INSTRUCTIONS. HOMERUN WITH LOOP CIRCUIT

3
E17
TYPE 'B'
NOT TO SCALE

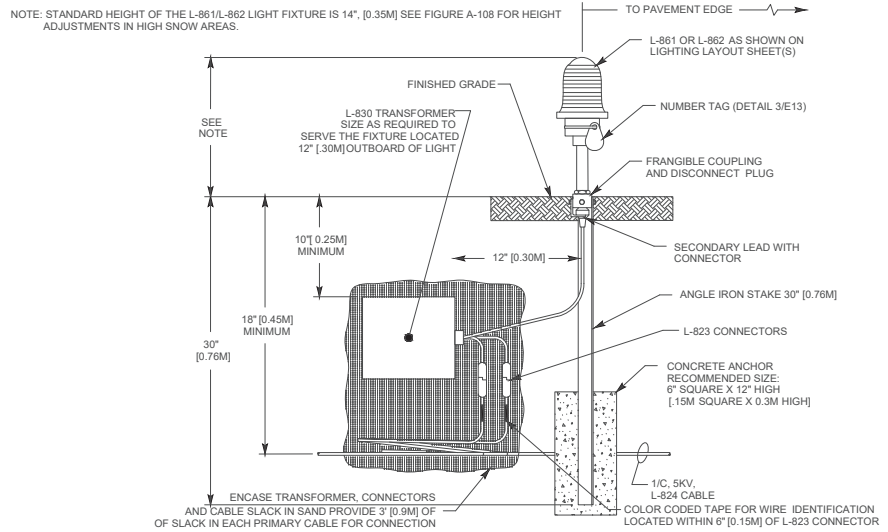

2
E17
MEDIUM/HIGH INTENSITY SERIES CIRCUIT LIGHT - STAKE MOUNTED
NOT TO SCALE

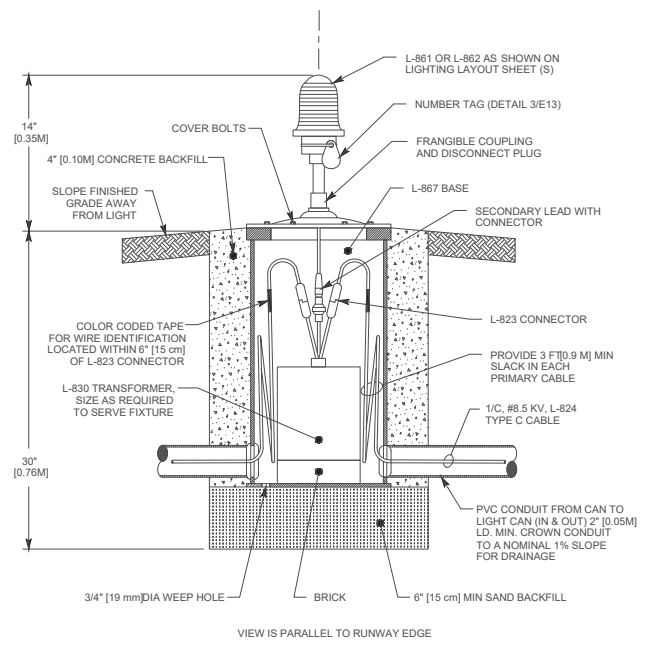

4
E17
MEDIUM/HIGH INTENSITY SERIES CIRCUIT LIGHT - BASE MOUNTED
NOT TO SCALE

VAUG220003




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ISSUE DATE	
100% SUBMITTAL	1/20/2023
DESIGNED BY:	JDZ
DRAWN BY:	JRA, JDZ
CHECKED BY:	JEA

ELECTRICAL DETAILS
AIRFIELD ELECTRICAL UPGRADE
DANIEL FIELD AIRPORT (DNL)
AUGUSTA, GEORGIA
AP019-XXX-XX(245)
GMC NUMBER : TAUG220004
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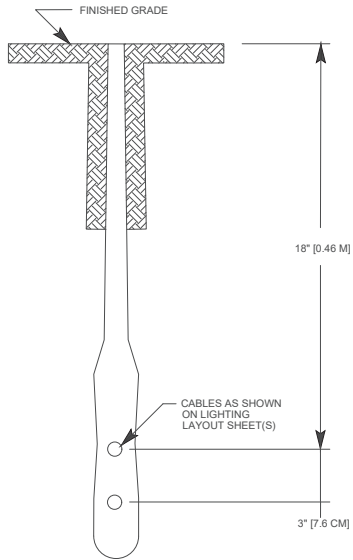
E17
Sheet 41 of 62





NOTES

1. TYPE AND MINIMUM NUMBER OF GROUND RODS ARE AS SPECIFIED ON THE PLAN.
2. INSTALL GROUND ROD AT MAXIMUM 500' [152.4 M] SPACING. USE GROUND ROD TO TERMINATE THE COUNTERPOISE AT BOTH ENDS OF DUCT.
3. COST OF GROUND RODS IS INCIDENTAL TO THE ASSOCIATED ITEMS REQUIRING GROUNDING UNLESS OTHERWISE SPECIFIED.
4. THE NUMBER OF GROUND RODS IS SITE SPECIFIC AND MAY DEPEND ON SOIL RESISTIVITY.

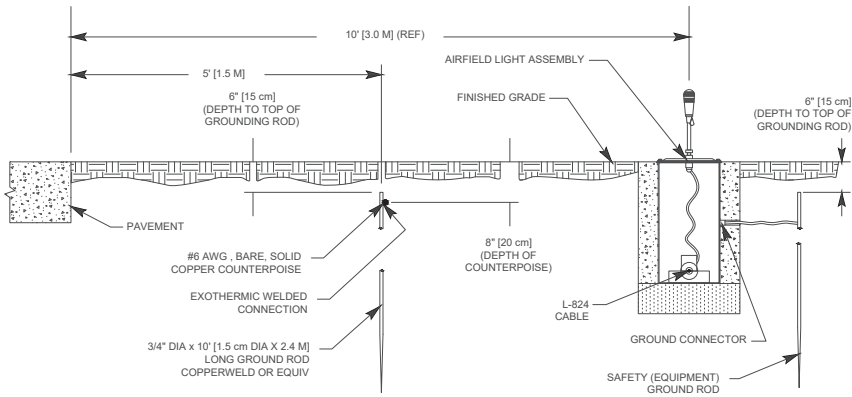1
E18
AIRFIELD GROUNDING
NOT TO SCALE



2
E18
TYPICAL DETAIL FOR UNDERGROUND CABLE INSTALLATION - PLOWED CABLE
NOT TO SCALE

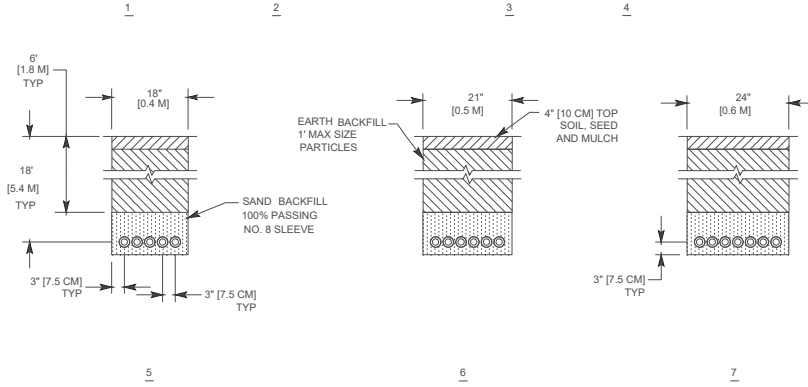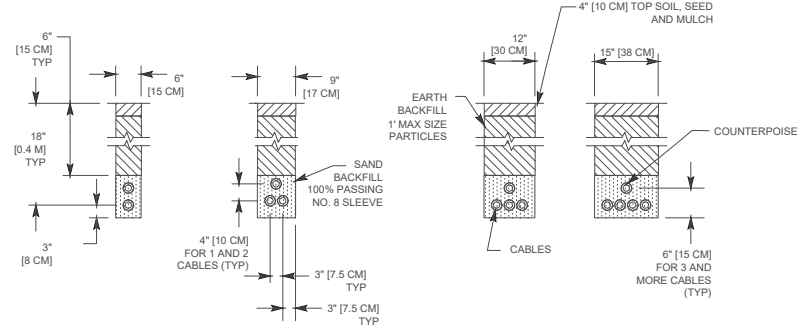

1. DETAIL NUMBERS INDICATE NO. OF CABLES.
2. INCREASE TRENCHES WITH MORE THAN 7 CABLES 3" [7.5 CM] IN WIDTH FOR EACH ADDITIONAL CABLE. IF SPECIFIED ON PLANS, TWO PARALLEL TRENCHES MAY BE CONSTRUCTED.
3. SHOW DEPTH OF TRENCHES ABOVE UNLESS OTHERWISE SPECIFIED ON THE PLANS.
4. SAND BACKFILL MAY BE WAIVED BY THE ENGINEER IF THE EXISTING SOIL MEETS THE BACKFILL REQUIREMENTS.
5. RESTORE ALL DISTURBED SURFACE TO THEIR ORIGINAL CONDITION. COST IS INCIDENTAL TO TRENCH RETURNING MATERIALS AND RATES MAY BE SHOWN ON THE PLAN.
6. SEE PARAGRAPH 12.5 FOR ADDITIONAL INFORMATION ABOUT COUNTERPOISE INSTALLATION.

3
E18
TYPICAL DETAIL FOR UNDERGROUND CABLE INSTALLATION - PLOWED CABLE
NOT TO SCALE

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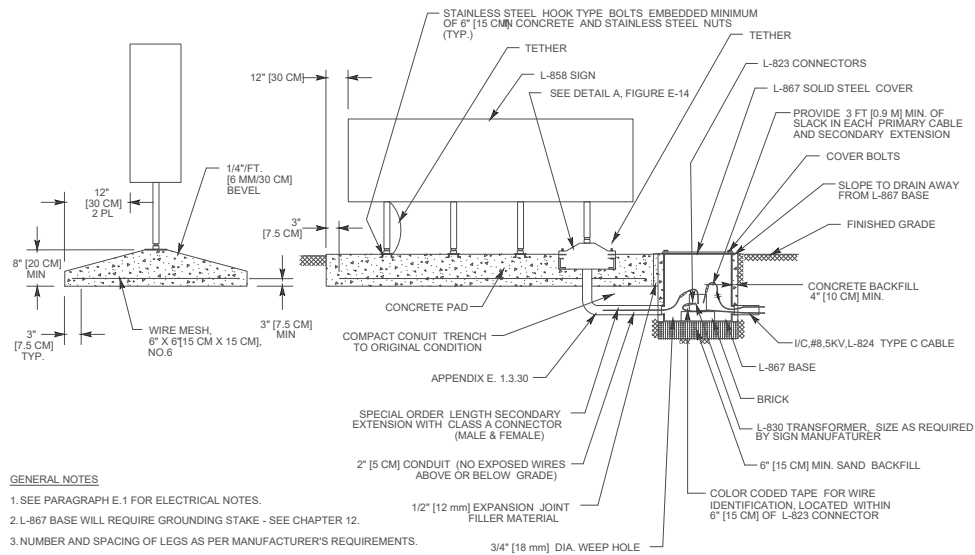
ISSUE DATE	ISSUE DESCRIPTION
1/20/2023	TOOKS SUBMITTAL
	DESIGNED BY: J.D.Z.
	DRAWN BY: J.R.A., J.D.Z.
	CHECKED BY: J.E.A.

AIRFIELD ELECTRICAL UPGRADE
DANIEL FIELD AIRPORT (DNL)
AUGUSTA, GEORGIA
AP019-XXX-XX(245)
GMC NUMBER : TAUG220004
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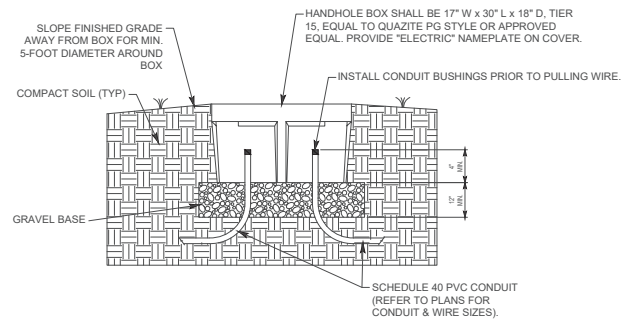


ELECTRICAL DETAILS


E18
Sheet 42 of 52



1 TYPICAL MULTIPLE PEDESTAL SIGN INSTALLATION
NOT TO SCALE



2 ELECTRICAL HANDHOLE BOX IN EARTH DETAIL
NOT TO SCALE

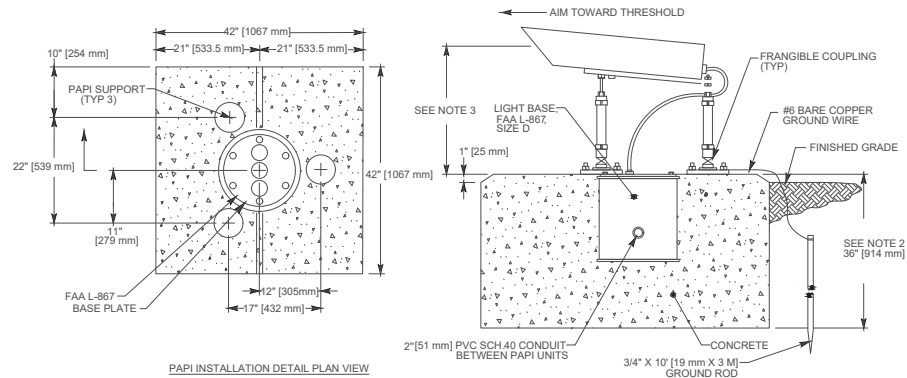

3 PAPI LIGHTING HOUSE UNIT (LHU) INSTALLATION DETAIL
NOT TO SCALE

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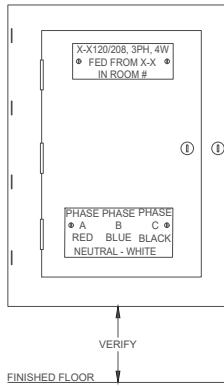
ISSUE DATE	ISSUE DESCRIPTION	DESIGNED BY	DRAWN BY	CHECKED BY
1/20/2023	TOOCS SUBMITTAL	JAZ	JRA, JAZ	JEA

ELECTRICAL DETAILS
AIRFIELD ELECTRICAL UPGRADE
DANIEL FIELD AIRPORT (DNL)



AUGUSTA, GEORGIA
AP019-XXX-XX(245)
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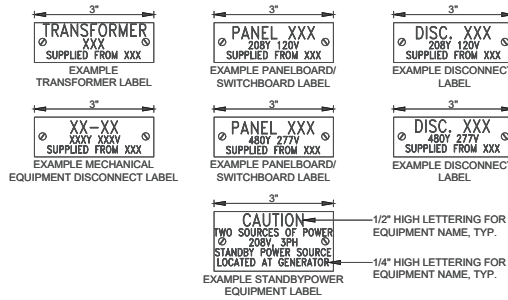
E19
Sheet 43 of 52



277/480, 3PH, 4W
 PHASE A - BROWN
 PHASE B - ORANGE
 PHASE C - YELLOW
 NEUTRAL - GRAY


NOTES:
 1. ADJUST AS REQUIRED FOR PROJECT VOLTAGE.

1 PANELBOARD INSTALLATION & NAME PLATE DETAIL
 E20 DIAGRAMMATIC




2 TYPICAL EQUIPMENT LABELING DETAIL
 E20 DIAGRAMMATIC

NOTES:
 1. ENGRAVED PLASTIC TAG WITH WHITE LETTERS ON BLACK BACKGROUND (RED BACKGROUND FOR EMERGENCY EQUIPMENT). TAG SHALL HAVE ALL EDGES BEVELED AND SMOOTH. SECURE TAG WITH 2 CHROME (STAINLESS STEEL FOR WET OR DAMP LOCATIONS) SCREWS.
 2. MINIMUM EQUIPMENT LABEL SIZE MUST BE LARGE ENOUGH TO ACCOMMODATE ALL TEXT.

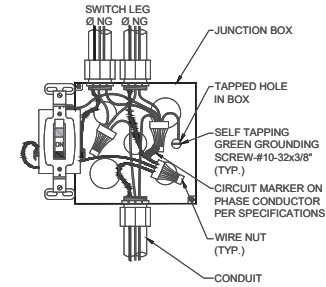


3 TYPICAL SWITCH WIRING DETAIL
 E20 DIAGRAMMATIC

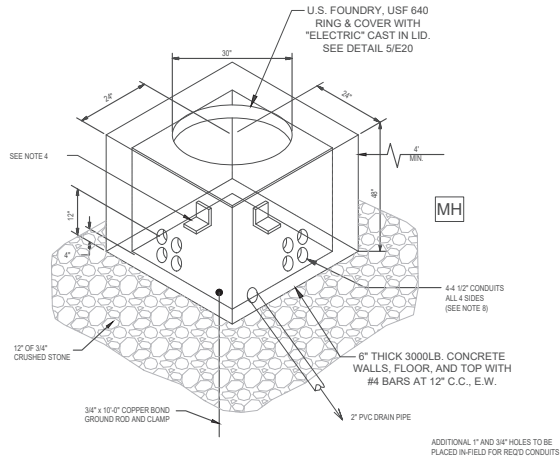


4 ELECTRICAL MANHOLE DETAIL (AT VAULT)
 E20 DIAGRAMMATIC

- MANHOLE NOTES:
1. CONCRETE SHALL BE 3,000 PSI.
 2. CAST IRON MANHOLE COVER SHALL READ "ELECTRICAL".
 3. CONCRETE SHALL BE COMPACTED WITH VIBRATOR.
 4. GALVANIZED STEEL OR FIBERGLASS CABLE BRACKETS/SUPPORTS - ALL 4 SIDES.
 5. HANDHOLE SHALL BE CONSTRUCTED FOR WHEEL-LOADING AS NOTED.
 6. HANDHOLE COVERS AND FRAMES SHALL NOT EXTEND MORE THAN 1 INCH ABOVE GRADE. USE BRICKS TO ELEVATE COVER AS NECESSARY.
 7. STANDARD HANDHOLE IS CAST WITH NO BOTTOM.
 8. UNUSED DUCT HOLES SHALL BE SEALED WITH REMOVABLE, WATERIGHT PLUGS.
 9. SHOWN FOR REFERENCE ELECTRICAL CONTRACTOR VERIFY ACTUAL FIELD CONDITIONS.
 10. MANHOLE WILL BE MODIFIED AS REQUIRED FOR NEW GRADE. THIS MAY INCLUDE RELOCATION OF CABLING.
 11. PENETRATIONS SHOWN FOR REFERENCE ONLY. SIZE, NUMBER, POINT OF ENTRY AND DEPTH OF EXISTING CONDUITS VARY. ELECTRICAL CONTRACTOR TO FIELD VERIFY PRIOR TO BID.
 12. GALVANIZED PULL IRONS SHALL BE PROVIDED ON 2 SIDES OPPOSITE OF EACH OTHER DIRECTLY BELOW THE DUCTS.

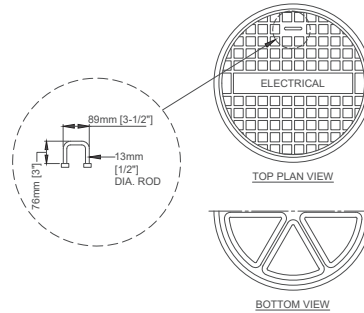


5 MANHOLE/HANDHOLE COVER
 E20 DIAGRAMMATIC

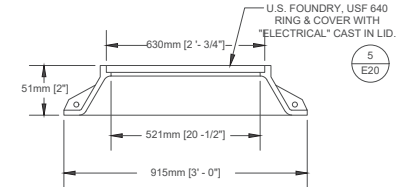


NOTE:
 1. PROVIDE 1#20 BARE COPPER GROUND FROM MANHOLE FRAME TO GROUND ROD IN MANHOLE.

6 MANHOLE FRAME AND COVER
 E20 DIAGRAMMATIC

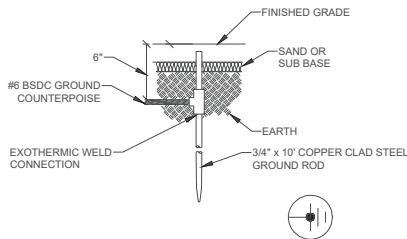

7 COUNTERPOISE GROUNDING ROD
 E20 DIAGRAMMATIC

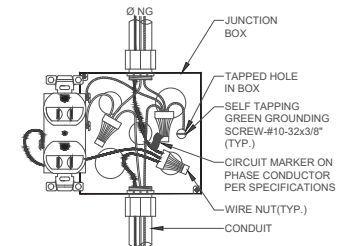

8 TYPICAL RECEPTACLE WIRING DETAIL
 E20 DIAGRAMMATIC




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DESIGNED BY:	J.D.Z.
DRAWN BY:	J.R.A., J.D.Z.
CHECKED BY:	J.E.A.

AIRFIELD ELECTRICAL UPGRADE
 DANIEL FIELD AIRPORT (DNL)


AUGUSTA, GEORGIA
 AP-19-XXX-XX(245)
 GMC NUMBER : TAUG220004
 SCALE: NOT TO SCALE

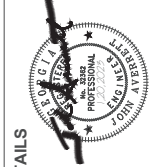

ELECTRICAL DETAILS

E20
 Sheet 44 of 62

VAUG220003

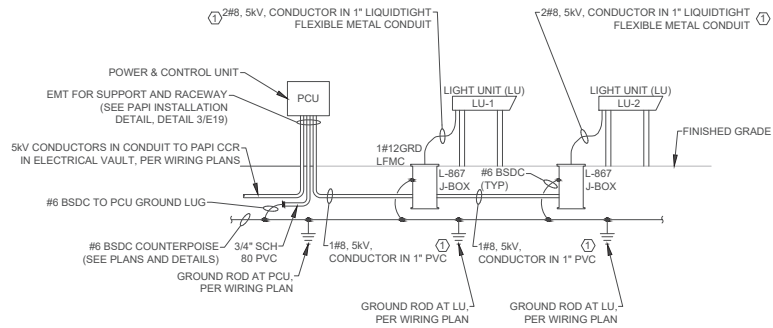


GENERAL NOTES:

- (APPLICABLE TO THIS RISER ONLY)
- A. THIS DETAIL IS BASED ON AN L-881 (2 LIGHT UNIT), STYLE B (6.6A CURRENT DRIVEN), CLASS I (-31 TO 131 DEG. F) PAPI AS MANUFACTURED BY ADB. REQUIREMENTS MAY VARY BETWEEN MANUFACTURERS. FINAL DETAIL SHALL BE APPROVED BY ENGINEER.
 - B. PERFORM INITIAL PCU SETUP AND CALIBRATION IN ACCORDANCE WITH THE MANUFACTURER'S INSTRUCTIONS.
 - C. SETUP NIGHTTIME INTENSITY FOR 5% OR 20%, BASED ON THE OWNER'S PREFERENCE. COORDINATE WITH OWNER.

KEYED NOTES:

- (APPLICABLE TO THIS RISER ONLY)
1. CABLE CONNECTORS FOR WIRING BETWEEN PCU AND LUS ARE TYPICALLY FURNISHED WITH PAPI.

1 PAPI SYSTEM RISER DIAGRAM
E21 NOT TO SCALE




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TOOLS SUBMITTED	1/20/2023
DESIGNED BY	JDZ
DRAWN BY	JRA, JDZ
CHECKED BY	JEA


ELECTRICAL DETAILS

AIRFIELD ELECTRICAL UPGRADE
DANIEL FIELD AIRPORT (DNL)

AUGUSTA, GEORGIA
 AP019-XXX-XX(245)
 GMC NUMBER : TAUG220004
 SCALE: NOT TO SCALE



E21
 Sheet 45 of 52

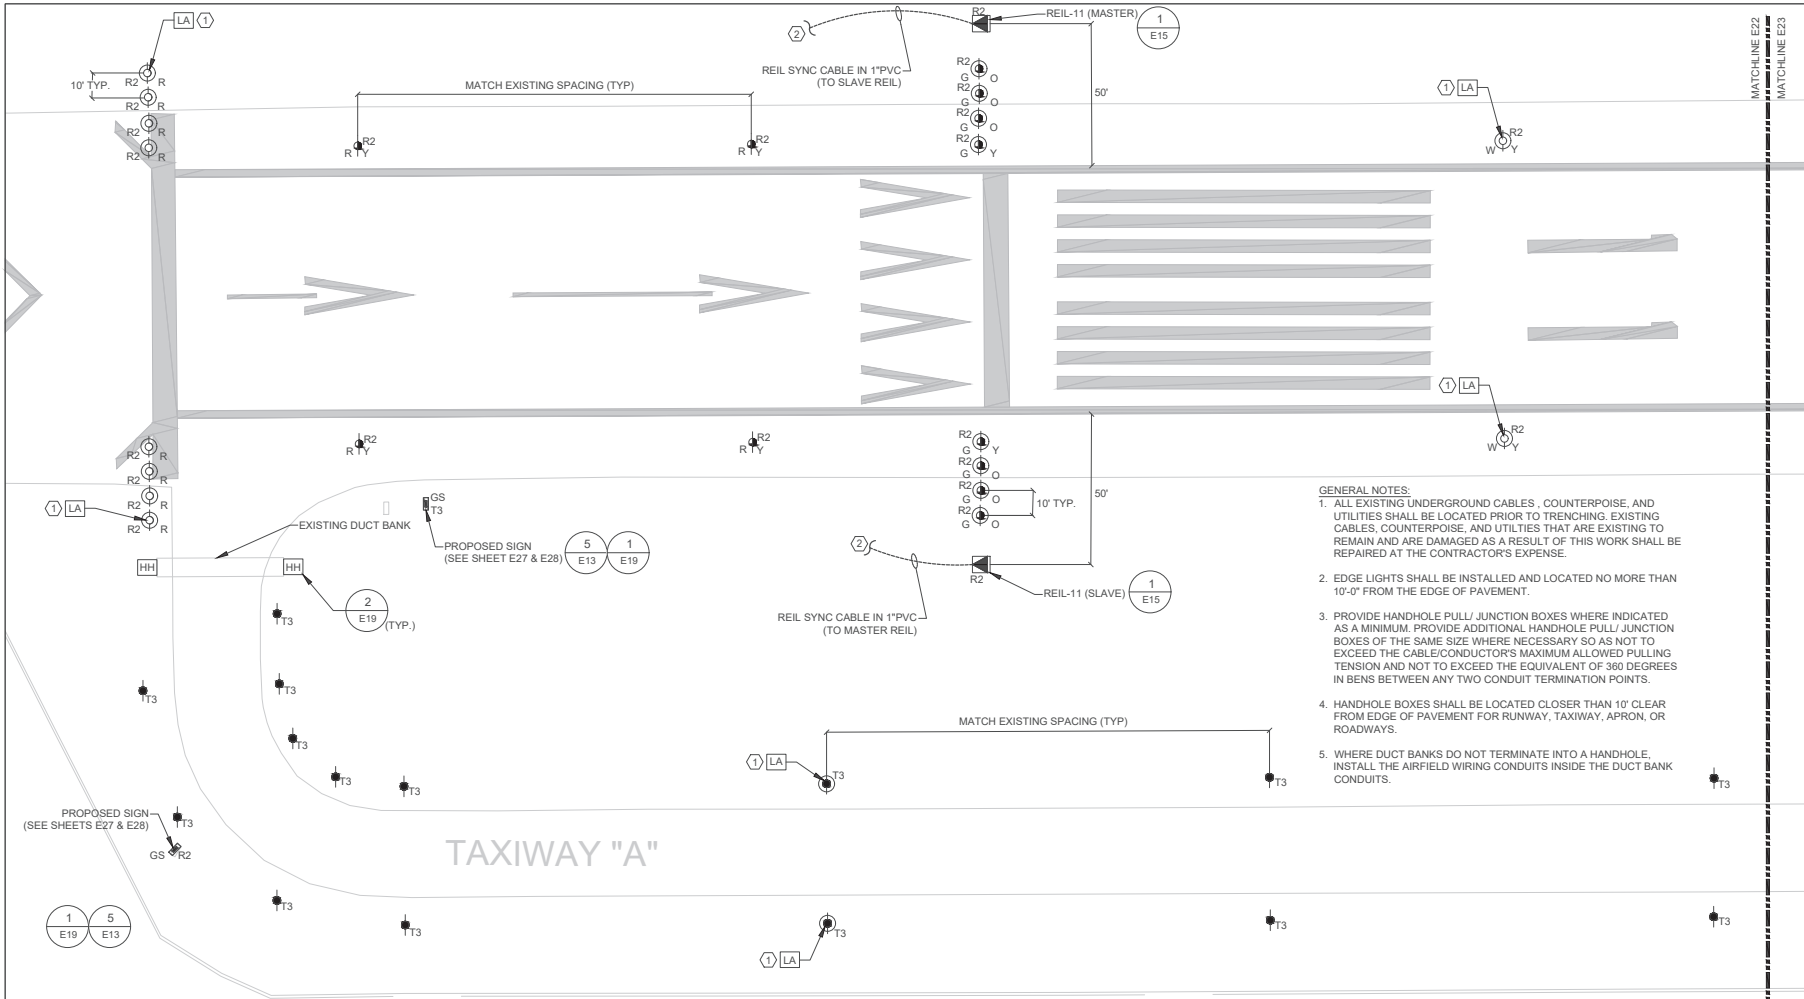

- GENERAL NOTES:**
1. ALL EXISTING UNDERGROUND CABLES, COUNTERPOISE, AND UTILITIES SHALL BE LOCATED PRIOR TO TRENCHING EXISTING CABLES, COUNTERPOISE, AND UTILITIES THAT ARE EXISTING TO REMAIN AND ARE DAMAGED AS A RESULT OF THIS WORK SHALL BE REPAIRED AT THE CONTRACTOR'S EXPENSE.
 2. EDGE LIGHTS SHALL BE INSTALLED AND LOCATED NO MORE THAN 10'-0" FROM THE EDGE OF PAVEMENT.
 3. PROVIDE HANDHOLE PULL/ JUNCTION BOXES WHERE INDICATED AS A MINIMUM. PROVIDE ADDITIONAL HANDHOLE PULL/ JUNCTION BOXES OF THE SAME SIZE WHERE NECESSARY SO AS NOT TO EXCEED THE CABLE/CONDUCTOR'S MAXIMUM ALLOWED PULLING TENSION AND NOT TO EXCEED THE EQUIVALENT OF 360 DEGREES IN BENS BETWEEN ANY TWO CONDUIT TERMINATION POINTS.
 4. HANDHOLE BOXES SHALL BE LOCATED CLOSER THAN 10' CLEAR FROM EDGE OF PAVEMENT FOR RUNWAY, TAXIWAY, APRON, OR ROADWAYS.
 5. WHERE DUCT BANKS DO NOT TERMINATE INTO A HANDHOLE, INSTALL THE AIRFIELD WIRING CONDUITS INSIDE THE DUCT BANK CONDUITS.

KEYED NOTES

1. PROVIDE FIELD LIGHTNING ARRESTOR FOR SERIES CIRCUIT AS SPECIFIED. LIGHTING ARRESTOR TO BE ADB #FL44A8102 OR APPROVED EQUAL. INSTALL ARRESTOR IN THE BASE CAN INDICATED AND CONNECT TO THE SERIES LIGHTING CIRCUIT PER MANUFACTURER'S REQUIREMENTS. GROUND PER NEC AND FAA REGULATIONS. GROUND ARRESTOR TO BASE CAN GROUND LUG USING A #4 COOPER GROUND CONDUCTOR. PROVIDE A RED TAG WITH WHITE "LA" LETTERS ON FIXTURE STEM. TAG SHALL MATCH DETAIL 3/E13 EXCEPT FOR THE COLOR.
2. PROVIDE 12"x12"x12" HANDHOLES PER HANDHOLE DETAIL 2/E19. FOR REIL SYNC CABLE CONDUIT AS REQUIRED SO AS NOT TO EXCEED THE CABLE'S MAXIMUM ALLOWED PULLING TENSION AND NOT TO EXCEED THE EQUIVALENT OF 360 DEGREES IN BENDS BETWEEN ANY TWO CONDUIT TERMINATION POINTS.




AIRFIELD LIGHTING & WIRING PLAN - RUNWAY 11/29 - PART 1 (ALTERNATE)

SCALE: 1"=50'-0"


NOTE:

1. CONTRACTOR TO MATCH EXISTING ROUTES AND ROUTE ALL NEW CABLES IN EXISTING TRENCHES, DUCT BANKS, ETC. TO ELECTRICAL VAULT. NEW CABLING CONSIST OF: 1#8, 1/C, SKV, L-824C CABLE IN 1" PVC 18" BELOW GRADE MIN., WITH 1#6 BSDC COUNTERPOISE CABLE 6" BELOW GRADE MIN. (TYPICAL FOR ONE (1) RUNWAY (R2) LIGHTING CIRCUIT AND ONE (1) TAXIWAY 'A' (T3) LIGHTING CIRCUIT UNO)

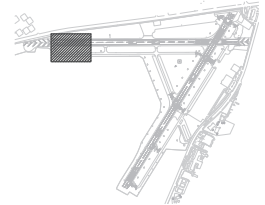

KEY PLAN
TRUE NORTH NOT TO SCALE

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AIRFIELD LIGHTING & WIRING PLAN - RUNWAY 11/29 - PART 1 (ALT)

DESIGNED BY: JAZ
DRAWN BY: JRA, JIZ
CHECKED BY: JEA

AIRFIELD ELECTRICAL UPGRADE DANIEL FIELD AIRPORT (DNL)

AUGUSTA, GEORGIA
AP-019-XXX-XX(245)
GMC NUMBER : TAUG220004
SCALE: 1"=50'



E22
Sheet 46 of 52


MATCHLINE E22
MATCHLINE E23

MATCHLINE E23
MATCHLINE E24



KEYED NOTES (4)

- PROVIDE FIELD LIGHTING ARRESTOR FOR SERIES CIRCUIT AS SPECIFIED LIGHTING ARRESTOR TO BE ADB #FL444A6102 OR APPROVED EQUAL. INSTALL ARRESTOR IN THE BASE CAN INDICATED AND CONNECT TO THE SERIES LIGHTING CIRCUIT PER MANUFACTURER'S REQUIREMENTS. GROUND PER NEC AND FAA REGULATIONS. GROUND ARRESTOR TO BASE CAN GROUND LUG USING A #4 COOPER GROUND CONDUCTOR. PROVIDE A RED TAG WITH WHITE "LA" LETTERS ON FIXTURE STEM. TAG SHALL MATCH DETAIL 3/E13 EXCEPT FOR THE COLOR.
- EXISTING PAPI TO REMAIN IN SERVICE - NO WORK REQUIRED.

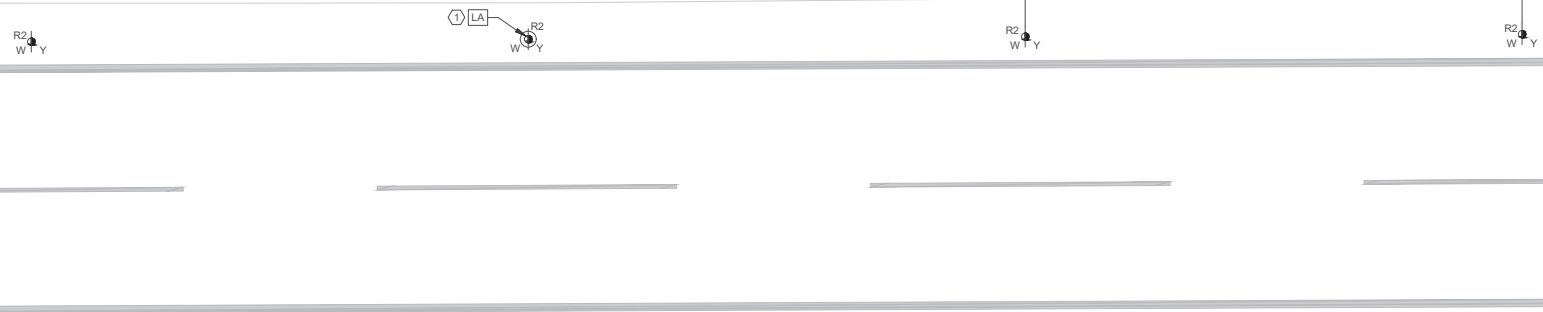


- GENERAL NOTES:**
- ALL EXISTING UNDERGROUND CABLES, COUNTERPOISE, AND UTILITIES SHALL BE LOCATED PRIOR TO TRENCHING. EXISTING CABLES, COUNTERPOISE, AND UTILITIES THAT ARE EXISTING TO REMAIN AND ARE DAMAGED AS A RESULT OF THIS WORK SHALL BE REPAIRED AT THE CONTRACTOR'S EXPENSE.
 - EDGE LIGHTS SHALL BE INSTALLED AND LOCATED NO MORE THAN 10'-0" FROM THE EDGE OF PAVEMENT.
 - PROVIDE HANDHOLE PULL/JUNCTION BOXES WHERE INDICATED AS A MINIMUM. PROVIDE ADDITIONAL HANDHOLE PULL/JUNCTION BOXES OF THE SAME SIZE WHERE NECESSARY SO AS NOT TO EXCEED THE CABLE/CONDUCTOR'S MAXIMUM ALLOWED PULLING TENSION AND NOT TO EXCEED THE EQUIVALENT OF 360 DEGREES IN BENS BETWEEN ANY TWO CONDUIT TERMINATION POINTS.
 - HANDHOLE BOXES SHALL BE LOCATED CLOSER THAN 10' CLEAR FROM EDGE OF PAVEMENT FOR RUNWAY, TAXIWAY, APRON, OR ROADWAYS.
 - WHERE DUCT BANKS DO NOT TERMINATE INTO A HANDHOLE, INSTALL THE AIRFIELD WIRING CONDUITS INSIDE THE DUCT BANK CONDUITS.

NOTE:

- CONTRACTOR TO MATCH EXISTING ROUTES AND ROUTE ALL NEW CABLES IN EXISTING TRENCHES, DUCT BANKS, ETC. TO ELECTRICAL VAULT. NEW CABLING CONSIST OF: 1#8, 1/C, 5KV, L-824C CABLE IN 1" PVC 18" BELOW GRADE MIN., WITH 1#6 BSDC COUNTERPOISE CABLE 6" BELOW GRADE MIN. (TYPICAL FOR ONE (1) RUNWAY (R2) LIGHTING CIRCUIT AND ONE (1) TAXIWAY 'A' (T3) LIGHTING CIRCUIT UNO)

TAXIWAY "A"

AIRFIELD LIGHTING & WIRING PLAN - RUNWAY 11/29 - PART 2 (ALTERNATE)
SCALE: 1"=50'-0"

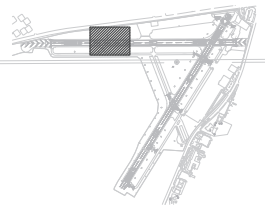

KEY PLAN
NOT TO SCALE

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DESIGNED BY:	J.D.Z.
DRAWN BY:	J.R.A., J.D.Z.
CHECKED BY:	J.R.A.

**AIRFIELD ELECTRICAL UPGRADE
DANIEL FIELD AIRPORT (DNL)**
AUGUSTA, GEORGIA
AP-019-XXX-XX(245)
GMC NUMBER : TAUG220004
SCALE: 1"=50'



**AIRFIELD LIGHTING
& WIRING PLAN
- RUNWAY 11/29
- PART 2 (ALT)**

E23


Sheet 47 of 52

MATCHLINE E23
MATCHLINE E24

MATCHLINE E24
MATCHLINE E25

GENERAL NOTES:


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5. WHERE DUCT BANKS DO NOT TERMINATE INTO A HANDHOLE, INSTALL THE AIRFIELD WIRING CONDUITS INSIDE THE DUCT BANK CONDUITS.

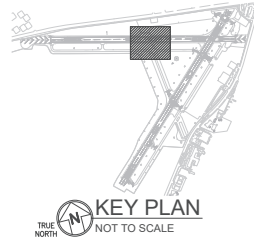

KEYED NOTES (#)

1. PROVIDE FIELD LIGHTNING ARRESTOR FOR SERIES CIRCUIT AS SPECIFIED. LIGHTING ARRESTOR TO BE ADB #FLA44A6102 OR APPROVED EQUAL. INSTALL ARRESTOR IN THE BASE CAN INDICATED AND CONNECT TO THE SERIES LIGHTING CIRCUIT PER MANUFACTURER'S REQUIREMENTS. GROUND PER NEC AND FAA REGULATIONS. GROUND ARRESTOR TO BASE CAN GROUND LUG USING A #4 COPPER GROUND CONDUCTOR. PROVIDE A RED TAG WITH WHITE "LA" LETTERS ON FIXTURE STEM. TAG SHALL MATCH DETAIL 3/E13 EXCEPT FOR THE COLOR.


NOTE:
1. CONTRACTOR TO MATCH EXISTING ROUTES AND ROUTE ALL NEW CABLES IN EXISTING TRENCHES, DUCT BANKS, ETC. TO ELECTRICAL VAULT. NEW CABLING CONSIST OF:
1#8, 1/C, 5KV, L-824C CABLE IN 1" PVC 18" BELOW GRADE MIN.
WITH 1#6 BSDC COUNTERPOISE CABLE 6" BELOW GRADE MIN (TYPICAL FOR ONE (1) RUNWAY (R2) LIGHTING CIRCUIT AND ONE (1) TAXIWAY 'A' (T3) LIGHTING CIRCUIT UNO)

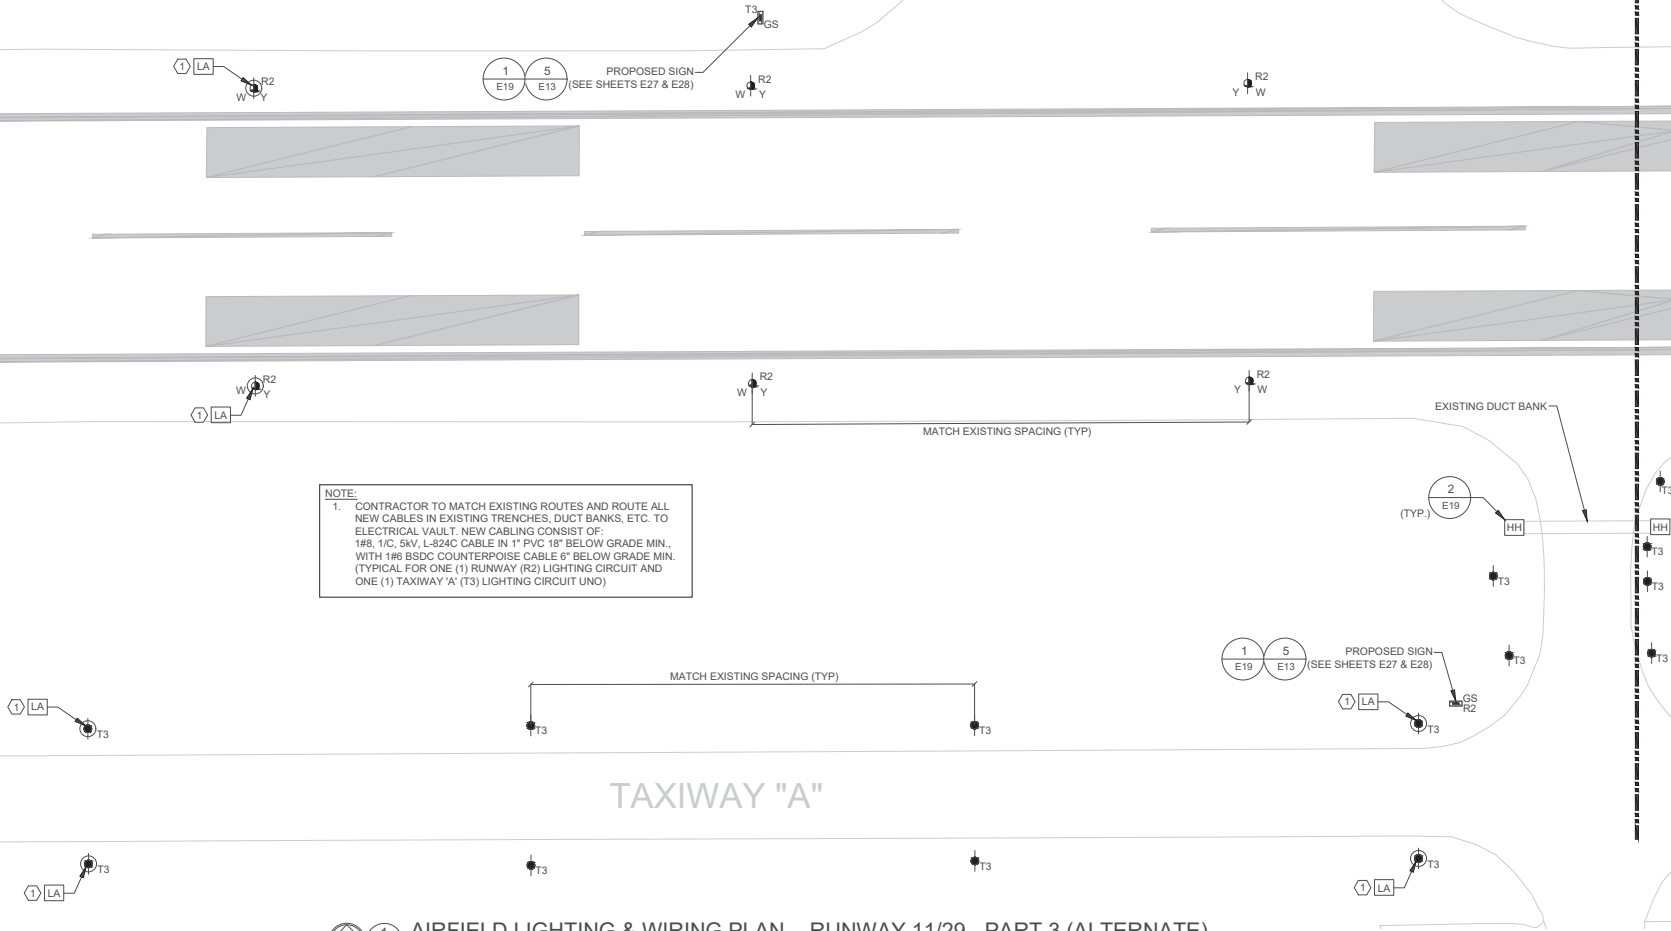

AIRFIELD LIGHTING & WIRING PLAN - RUNWAY 11/29 - PART 3 (ALTERNATE)

SCALE: 1"=50'-0"

VAUG220003



801 Broad Street, Suite 900
Augusta, GA 30901
T 807.303.3272
GMCNETWORK.COM

ISSUE DATE	1/20/2023
TOOKS SUBMITTAL	
DESIGNED BY	JDZ
DRAWN BY	JRA, JDZ
CHECKED BY	JEA


AIRFIELD LIGHTING & WIRING PLAN - RUNWAY 11/29 - PART 3 (ALT)

AIRFIELD ELECTRICAL UPGRADE DANIEL FIELD AIRPORT (DNL)

AUGUSTA, GEORGIA
AP-019-XXX-XX(245)
GMC NUMBER : TAUG220004
SCALE: 1"=50'



E24
Sheet 46 of 52

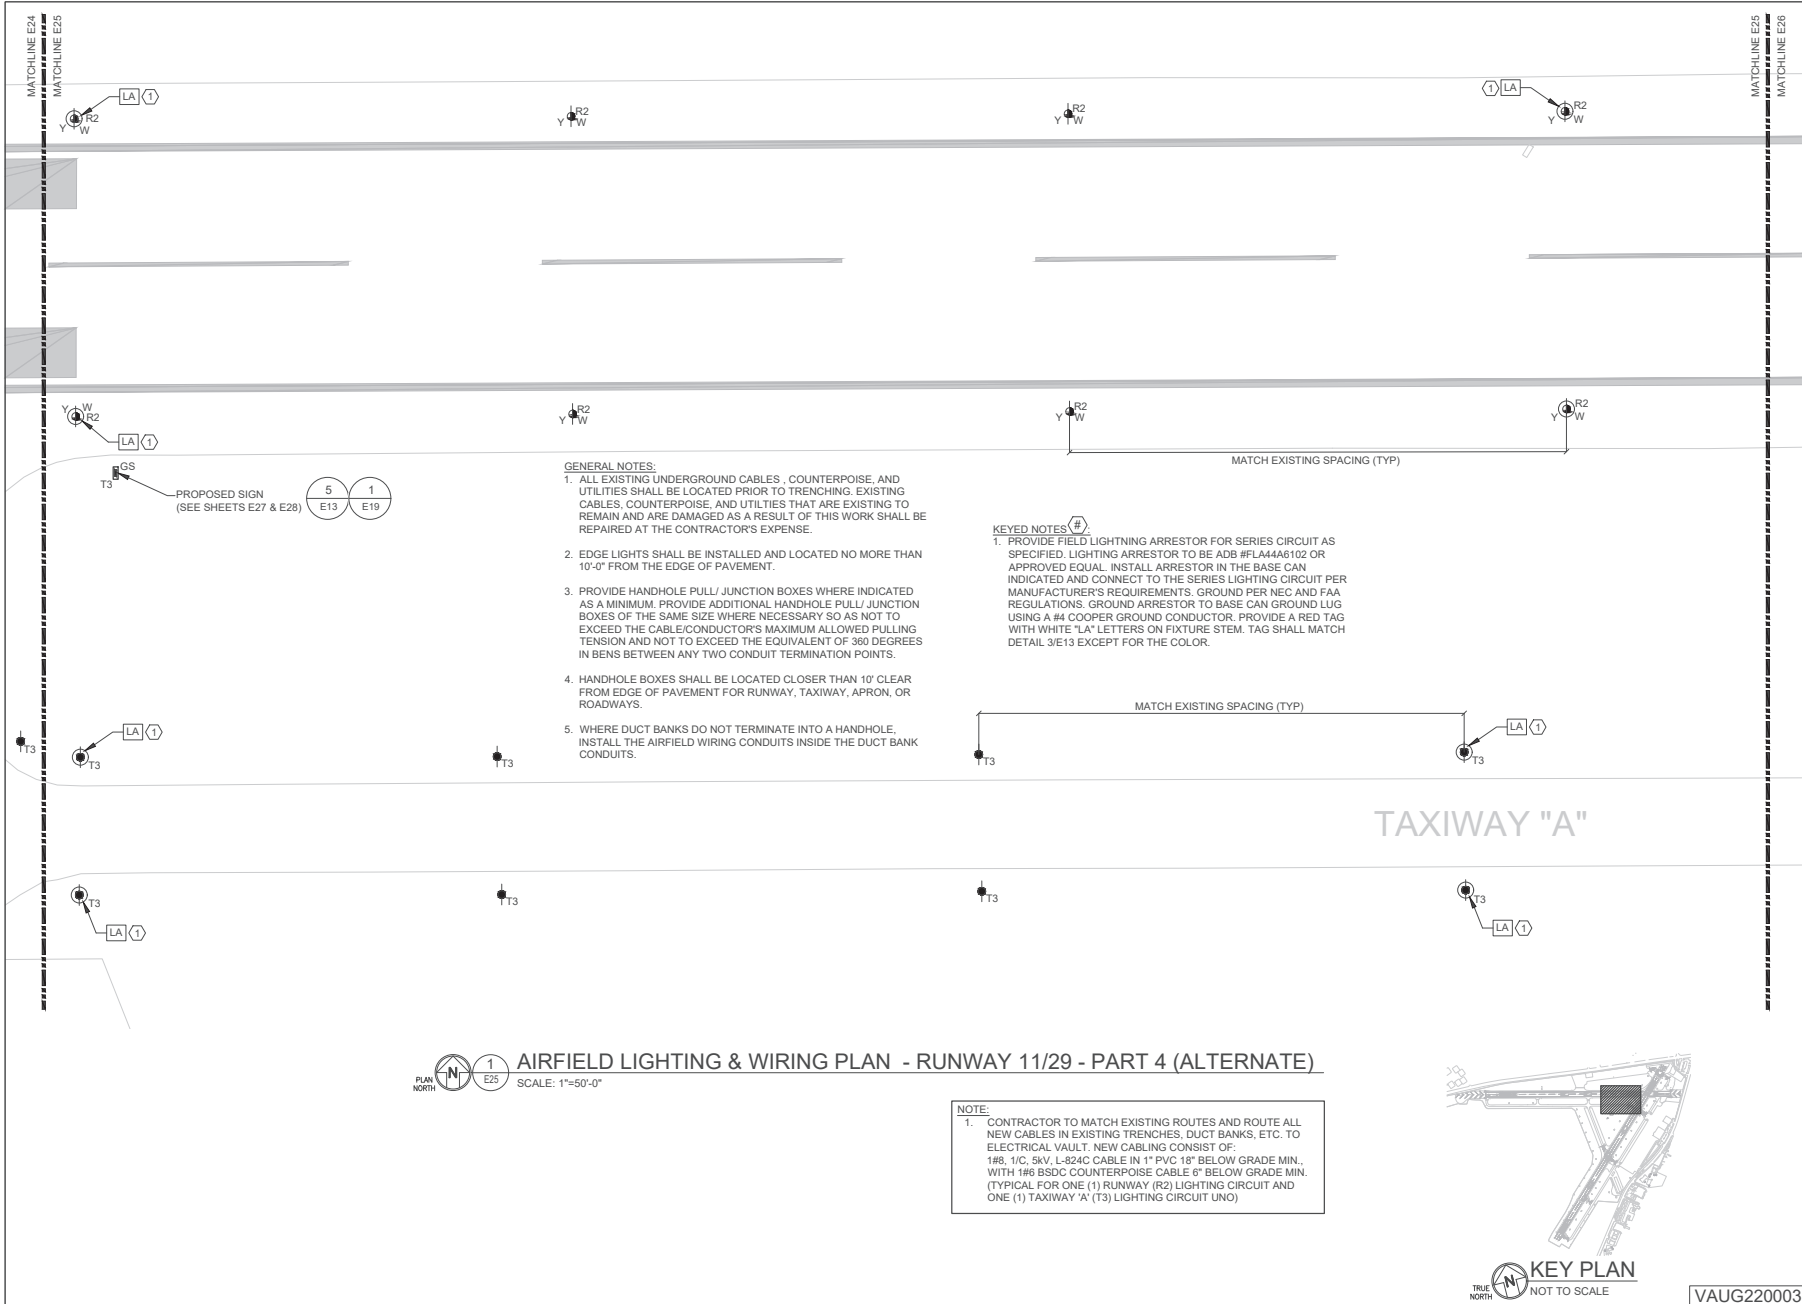

- GENERAL NOTES:**
1. ALL EXISTING UNDERGROUND CABLES, COUNTERPOISE, AND UTILITIES SHALL BE LOCATED PRIOR TO TRENCHING. EXISTING CABLES, COUNTERPOISE, AND UTILITIES THAT ARE EXISTING TO REMAIN AND ARE DAMAGED AS A RESULT OF THIS WORK SHALL BE REPAIRED AT THE CONTRACTOR'S EXPENSE.
 2. EDGE LIGHTS SHALL BE INSTALLED AND LOCATED NO MORE THAN 10'-0" FROM THE EDGE OF PAVEMENT.
 3. PROVIDE HANDHOLE PULL/ JUNCTION BOXES WHERE INDICATED AS A MINIMUM. PROVIDE ADDITIONAL HANDHOLE PULL/ JUNCTION BOXES OF THE SAME SIZE WHERE NECESSARY SO AS NOT TO EXCEED THE CABLE/CONDUCTOR'S MAXIMUM ALLOWED PULLING TENSION AND NOT TO EXCEED THE EQUIVALENT OF 360 DEGREES IN BENS BETWEEN ANY TWO CONDUIT TERMINATION POINTS.
 4. HANDHOLE BOXES SHALL BE LOCATED CLOSER THAN 10' CLEAR FROM EDGE OF PAVEMENT FOR RUNWAY, TAXIWAY, APRON, OR ROADWAYS.
 5. WHERE DUCT BANKS DO NOT TERMINATE INTO A HANDHOLE, INSTALL THE AIRFIELD WIRING CONDUITS INSIDE THE DUCT BANK CONDUITS.

- KEYED NOTES (#)**
1. PROVIDE FIELD LIGHTING ARRESTOR FOR SERIES CIRCUIT AS SPECIFIED. LIGHTING ARRESTOR TO BE ADB #FLA44A6102 OR APPROVED EQUAL. INSTALL ARRESTOR IN THE BASE CAN INDICATED AND CONNECT TO THE SERIES LIGHTING CIRCUIT PER MANUFACTURER'S REQUIREMENTS. GROUND PER NEC AND FAA REGULATIONS. GROUND ARRESTOR TO BASE CAN GROUND LUG USING A #4 COOPER GROUND CONDUCTOR. PROVIDE A RED TAG WITH WHITE "LA" LETTERS ON FIXTURE STEM. TAG SHALL MATCH DETAIL 3/E13 EXCEPT FOR THE COLOR.


PROPOSED SIGN
(SEE SHEETS E27 & E28)



AIRFIELD LIGHTING & WIRING PLAN - RUNWAY 11/29 - PART 4 (ALTERNATE)

SCALE: 1"=50'-0"

- NOTE:**
1. CONTRACTOR TO MATCH EXISTING ROUTES AND ROUTE ALL NEW CABLES IN EXISTING TRENCHES, DUCT BANKS, ETC. TO ELECTRICAL VAULT. NEW CABLING CONSIST OF:
1#8, 1/C, 5KV, L-824C CABLE IN 1" PVC 18" BELOW GRADE MIN., WITH 1#6 BSDC COUNTERPOISE CABLE 6" BELOW GRADE MIN. (TYPICAL FOR ONE (1) RUNWAY (R2) LIGHTING CIRCUIT AND ONE (1) TAXIWAY 'A' (T3) LIGHTING CIRCUIT UNO)

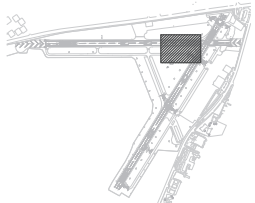

KEY PLAN
TRUE NORTH NOT TO SCALE



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ISSUE DATE

TOOCS: SUBMITTAL	1/20/2023
designed by:	JAZ
drawn by:	JRA, JDZ
checked by:	JEA

**AIRFIELD ELECTRICAL UPGRADE
DANIEL FIELD AIRPORT (DNL)**


AUGUSTA, GEORGIA
AP-019-XXX-XX(245)
GMC NUMBER : TAUG220004
SCALE: 1"=50'



**AIRFIELD LIGHTING
& WIRING PLAN
- RUNWAY 11/29
- PART 4 (ALT)**

E25
Sheet 49 of 52

VAUG220003

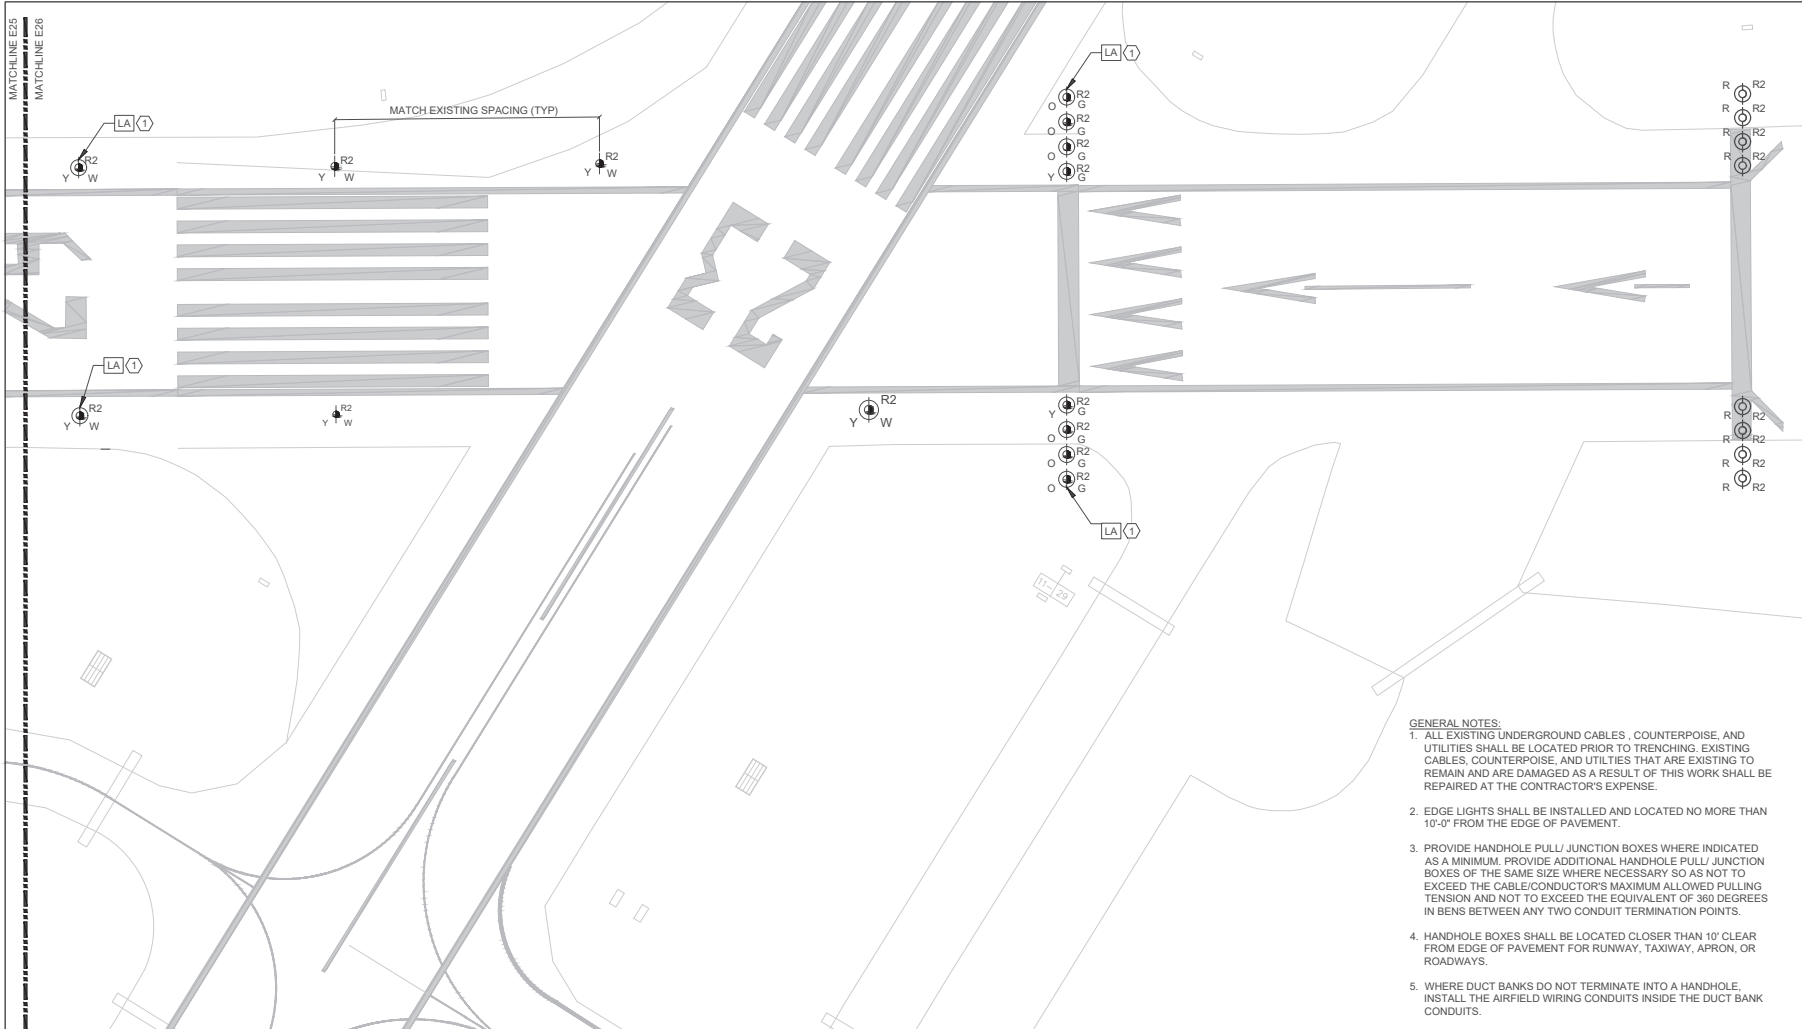

KEYED NOTES (#)

1. PROVIDE FIELD LIGHTNING ARRESTOR FOR SERIES CIRCUIT AS SPECIFIED. LIGHTING ARRESTOR TO BE ADB #FL4446 102 OR APPROVED EQUAL. INSTALL ARRESTOR IN THE BASE CAN INDICATED AND CONNECT TO THE SERIES LIGHTING CIRCUIT PER MANUFACTURER'S REQUIREMENTS. GROUND PER NEC AND FAA REGULATIONS. GROUND ARRESTOR TO BASE CAN GROUND LUG USING A #4 COOPER GROUND CONDUCTOR. PROVIDE A RED TAG WITH WHITE "LA" LETTERS ON FIXTURE STEM. TAG SHALL MATCH DETAIL 3/E13 EXCEPT FOR THE COLOR.

PLAN NORTH **1** **E26** **SCALE: 1"=60'-0"**

NOTE:


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- GENERAL NOTES:**
- ALL EXISTING UNDERGROUND CABLES, COUNTERPOISE, AND UTILITIES SHALL BE LOCATED PRIOR TO TRENCHING. EXISTING CABLES, COUNTERPOISE, AND UTILITIES THAT ARE EXISTING TO REMAIN AND ARE DAMAGED AS A RESULT OF THIS WORK SHALL BE REPAIRED AT THE CONTRACTOR'S EXPENSE.
 - EDGE LIGHTS SHALL BE INSTALLED AND LOCATED NO MORE THAN 10'-0" FROM THE EDGE OF PAVEMENT.
 - PROVIDE HANDHOLE PULL/JUNCTION BOXES WHERE INDICATED AS A MINIMUM. PROVIDE ADDITIONAL HANDHOLE PULL/JUNCTION BOXES OF THE SAME SIZE WHERE NECESSARY SO AS NOT TO EXCEED THE CABLE/CONDUCTOR'S MAXIMUM ALLOWED PULLING TENSION AND NOT TO EXCEED THE EQUIVALENT OF 360 DEGREES IN BENS BETWEEN ANY TWO CONDUIT TERMINATION POINTS.
 - HANDHOLE BOXES SHALL BE LOCATED CLOSER THAN 10' CLEAR FROM EDGE OF PAVEMENT FOR RUNWAY, TAXIWAY, APRON, OR ROADWAYS.
 - WHERE DUCT BANKS DO NOT TERMINATE INTO A HANDHOLE, INSTALL THE AIRFIELD WIRING CONDUITS INSIDE THE DUCT BANK CONDUITS.



KEY PLAN
 TRUE NORTH NOT TO SCALE

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
ISSUE DATE	
TOOKS SUBMITTAL	1/20/2023
DESIGNED BY:	JDZ
DRAWN BY:	JRA, JDZ
CHECKED BY:	JEA

AIRFIELD LIGHTING & WIRING PLAN
- RUNWAY 11/29 - PART 5 (ALT)


E26
 Sheet 50 of 52

AIRFIELD ELECTRICAL UPGRADE
DANIEL FIELD AIRPORT (DNL)

AUGUSTA, GEORGIA
 AP019-XXX-XX(245)
 GMC NUMBER : TAUG220004
 SCALE: 1" = 60"



SIGN CHART	
S26	←-C
S27	29-11
S28	←-RMP
S29	←-B
S30	←-LS
S31	←-A
S32	←-LA
S33	←-LA

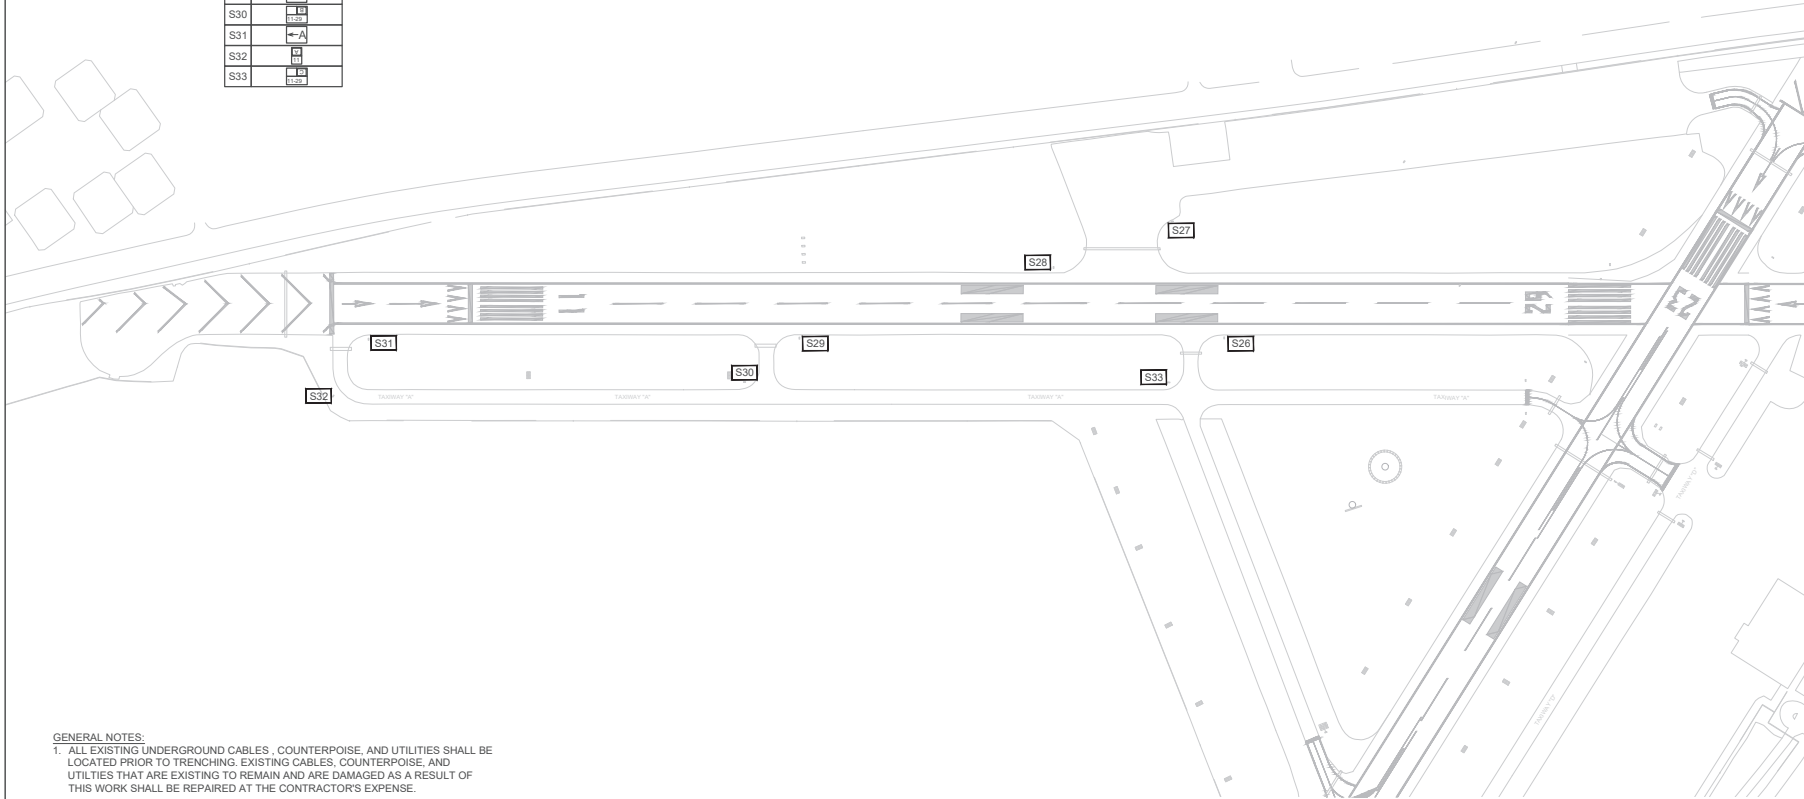


- GENERAL NOTES:**
1. ALL EXISTING UNDERGROUND CABLES, COUNTERPOISE, AND UTILITIES SHALL BE LOCATED PRIOR TO TRENCHING. EXISTING CABLES, COUNTERPOISE, AND UTILITIES THAT ARE EXISTING TO REMAIN AND ARE DAMAGED AS A RESULT OF THIS WORK SHALL BE REPAIRED AT THE CONTRACTOR'S EXPENSE.
 2. ALL AIRPORT SIGNS SHALL CONFORM TO THE FOLLOWING FAA ADVISORY CIRCULARS:
150/5340-18F STANDARDS FOR AIRPORT SIGN SYSTEMS
150/5340-30J DESIGN AND INSTALLATION DETAILS FOR AIRPORT VISUAL AIDS
150/5345-44J SPECIFICATION FOR RUNWAY & TAXIWAY SIGNS.
 3. ALL SIGNS SHALL BE SIZE 1, STYLE 2, CLASS 2, MODE 2, UNLESS DIRECTED OTHERWISE BY THE ENGINEER.
 4. CONTRACTOR SHALL STAKE THE LOCATION OF ALL PROPOSED SIGNS FOR REVIEW BY THE RPR PRIOR TO INSTALLATION.
 5. TYPICAL, SEE SHEET E10 FOR SIGN LAYOUTS.




AIRFIELD SIGN CHART PLAN - RUNWAY 11-29 (ALTERNATE)

SCALE: 1"=300'-0"

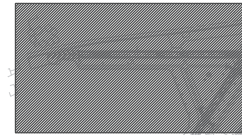

KEY PLAN
NOT TO SCALE

VAUG220003




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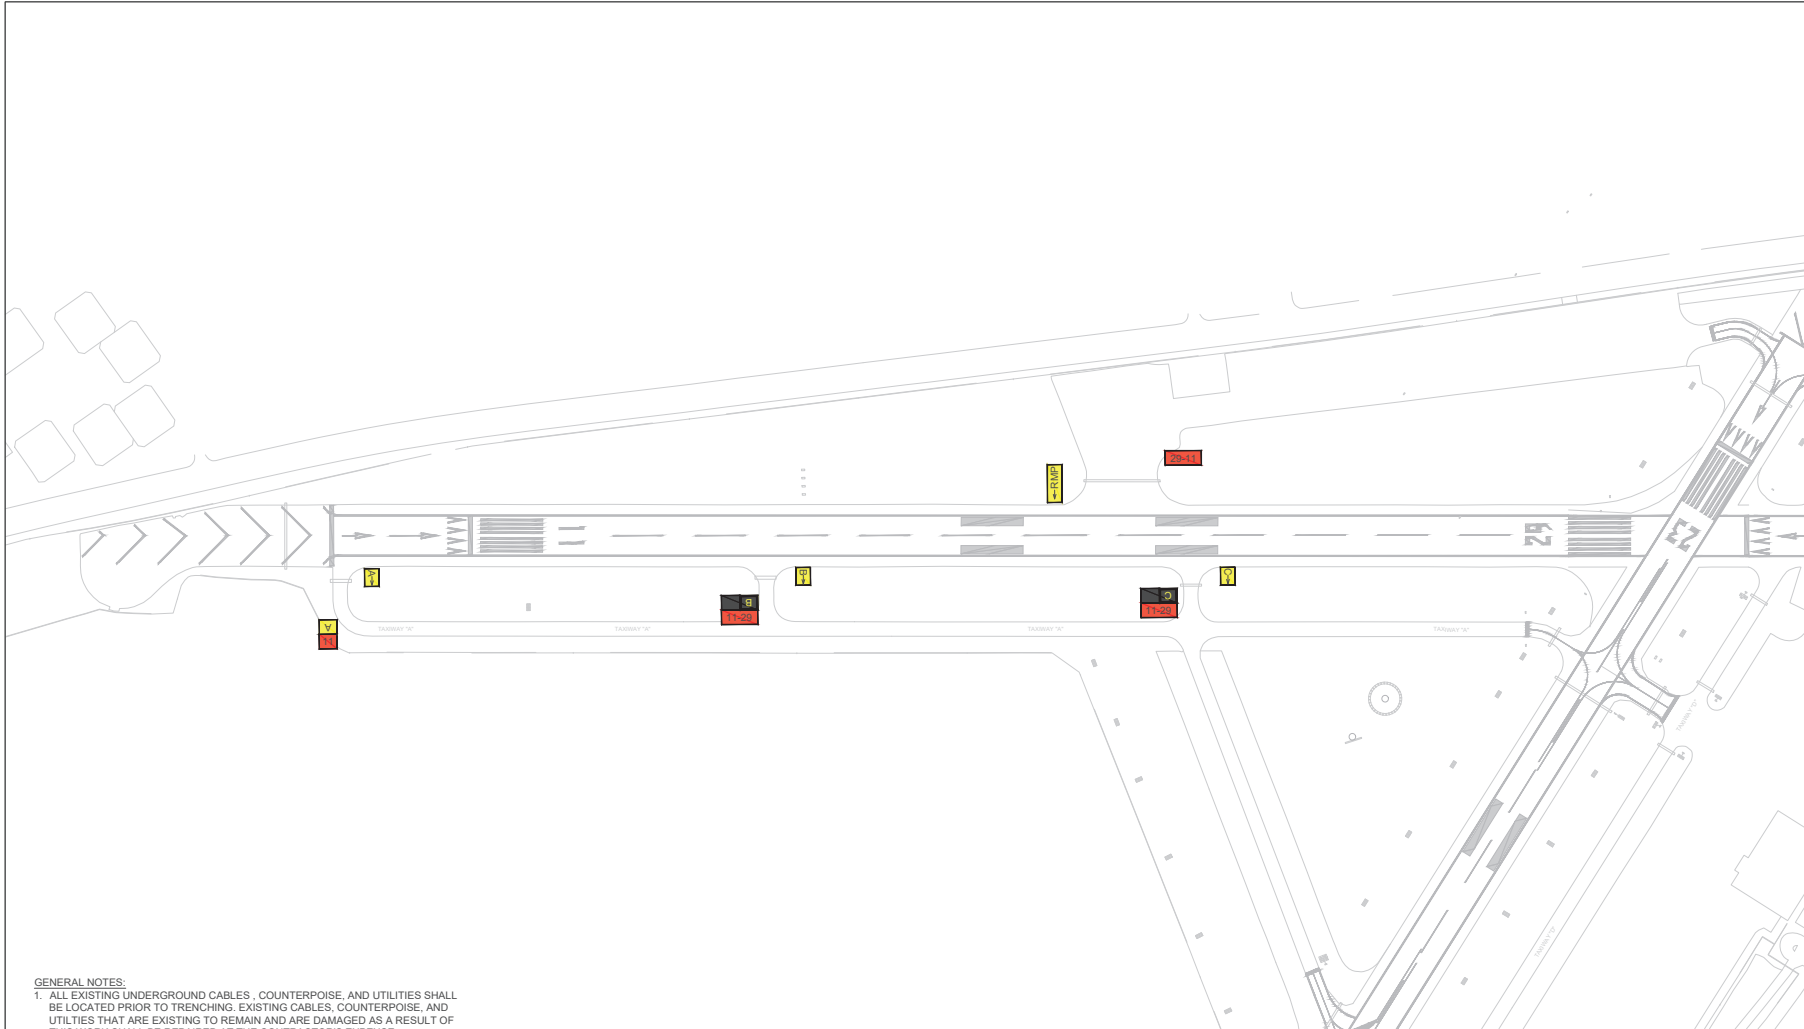
ISSUE DATE	
TOOKS SUBMITTAL	1/20/2023
DESIGNED BY:	JDZ
DRAWN BY:	JRA, JDZ
CHECKED BY:	JEA

**AIRFIELD ELECTRICAL UPGRADE
DANIEL FIELD AIRPORT (DNL)**

AUGUSTA, GEORGIA
AP019-XXX-XX(245)
GMC NUMBER : TAUG220004
SCALE: 1" = 300'



AIRFIELD SIGN CHART PLAN - RUNWAY 11-29 ALTERNATE
E27
Sheet 51 of 52




GENERAL NOTES:

1. ALL EXISTING UNDERGROUND CABLES, COUNTERPOISE, AND UTILITIES SHALL BE LOCATED PRIOR TO TRENCHING. EXISTING CABLES, COUNTERPOISE, AND UTILITIES THAT ARE EXISTING TO REMAIN AND ARE DAMAGED AS A RESULT OF THIS WORK SHALL BE REPAIRED AT THE CONTRACTOR'S EXPENSE.
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4. CONTRACTOR SHALL STAKE THE LOCATION OF ALL PROPOSED SIGNS FOR REVIEW BY THE RPR PRIOR TO INSTALLATION.



AIRFIELD SIGN LAYOUT PLAN - RUNWAY 11-29 (ALTERNATE)

SCALE: 1"=300'-0"

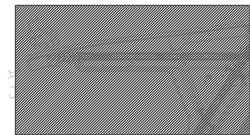

KEY PLAN
NOT TO SCALE

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TOOKS SUBMITTAL	1/20/2023
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**AIRFIELD ELECTRICAL UPGRADE
 DANIEL FIELD AIRPORT (DNL)**

AUGUSTA, GEORGIA
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 GMC NUMBER : TAUG220004
 SCALE: 1" = 300'



**AIRFIELD SIGN
 LAYOUT PLAN
 - RUNWAY 11-29
 ALTERNATE**

E28
 Sheet 52 of 52